DRAWING INDEX SITE MAP AREA MAP

AO-O COVER SHEET
AI-O BUILDING SITE PLAN
AI-I BUIDLING FLOOR PLAN
PHASE ONE DRAWINGS:

A2-I PHASE ONE - EXTERIOR ELEVATIONS
A2-2 PHASE ONE - EXTERIOR ELEVATIONS
A2-3 PHASE ONE - EXTERIOR ELEVATIONS
A2-4 PHASE ONE - EXTERIOR ELEVATIONS
A2-5 PHASE ONE - EXTERIOR ELEVATIONS
A2-6 PHASE ONE - EXTERIOR ELEVATIONS
PHASE TWO DRAWINGS:


A3-3 PHASE TWO - EXTERIOR ELEVATIONS
A3-4 PHASE TWO - EXTERIOR ELEVATIONS
PHASE THREE DRAWINGS:
A4-1 PHASE THREE - EXTERIOR ELEVATIONS
A4-2 PHASE THREE - EXTERIOR ELEVATIONS


A4-3 PHASE THREE - EXTERIOR ELEVATIONS

A3-1 PHASE TWO - EXTERIOR ELEVATIONS
A3-2 PHASE TWO - EXTERIOR ELEVATIONS

A5-I WINDOW FLASHING DETAILS A5-2 WINDOW FLASHING DETAILS A5-3 WINDOW DETAILS



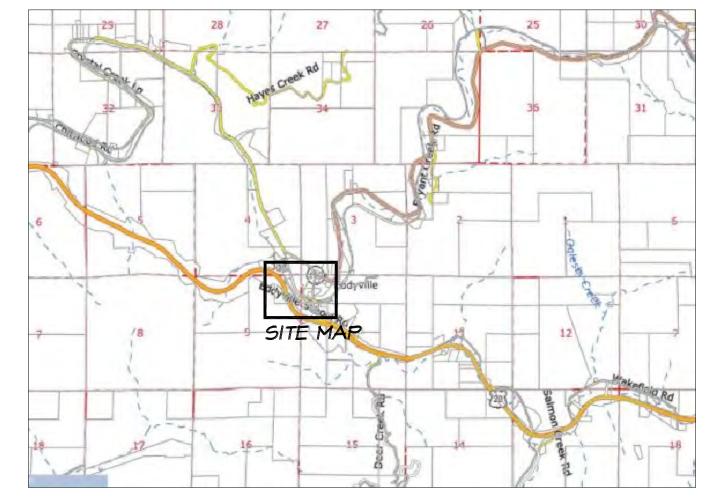

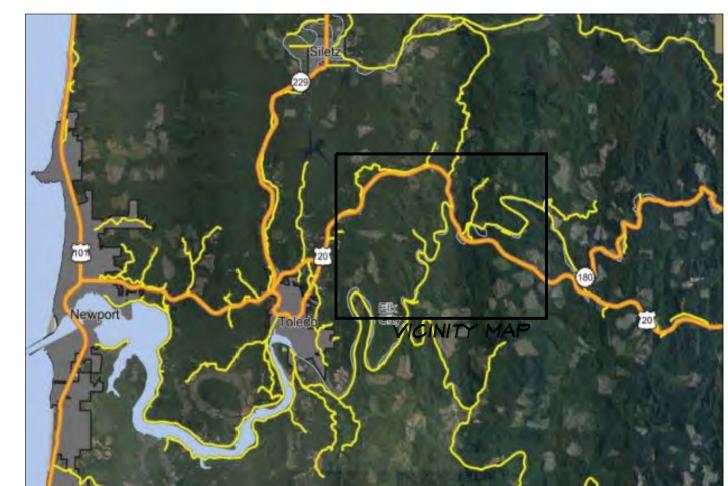

PROJECT TEAM

ARCHITECT SPECIFICATIONS OWNER EDDYVILLE CHARTER SCHOOL ARCHITECTURAL SPECIFICATIONS CONSULTANT DHGoebel, Architect Danny Wheeler Dietmar H. Goebel Linn West 1410 KING STREET I EDDYVILLE SCHOOL RD. PO BOX 2067 NEWPORT, OREGON 97365 YACHATS, OREGON 97498 EDDYVILLE, OREGON 97343 PHONE: 541-270-2758 PHONE: 541-974-5734 PHONE: 541-206-0140 EMAIL: danny.wheeler@lincoln.kl2.or.us EMAIL: dhgoebel42@gmail.com EMAIL: linnarchspec@gmail.com

EDDYVILLE CHARTER SCHOOL











EDDYVILLE SCHOOL

EDDYVILLE, OREGON EXTERIOR SIDING REMODEL

Oregon Coast Architect


147 NE Golf Course Drive - Newport, Oregon 97365


DATE: 07.30.22 SCALE: 1/8" = 1'-0"

ARCHITECT: Dietmar H. Goebel

DRAWN BY:



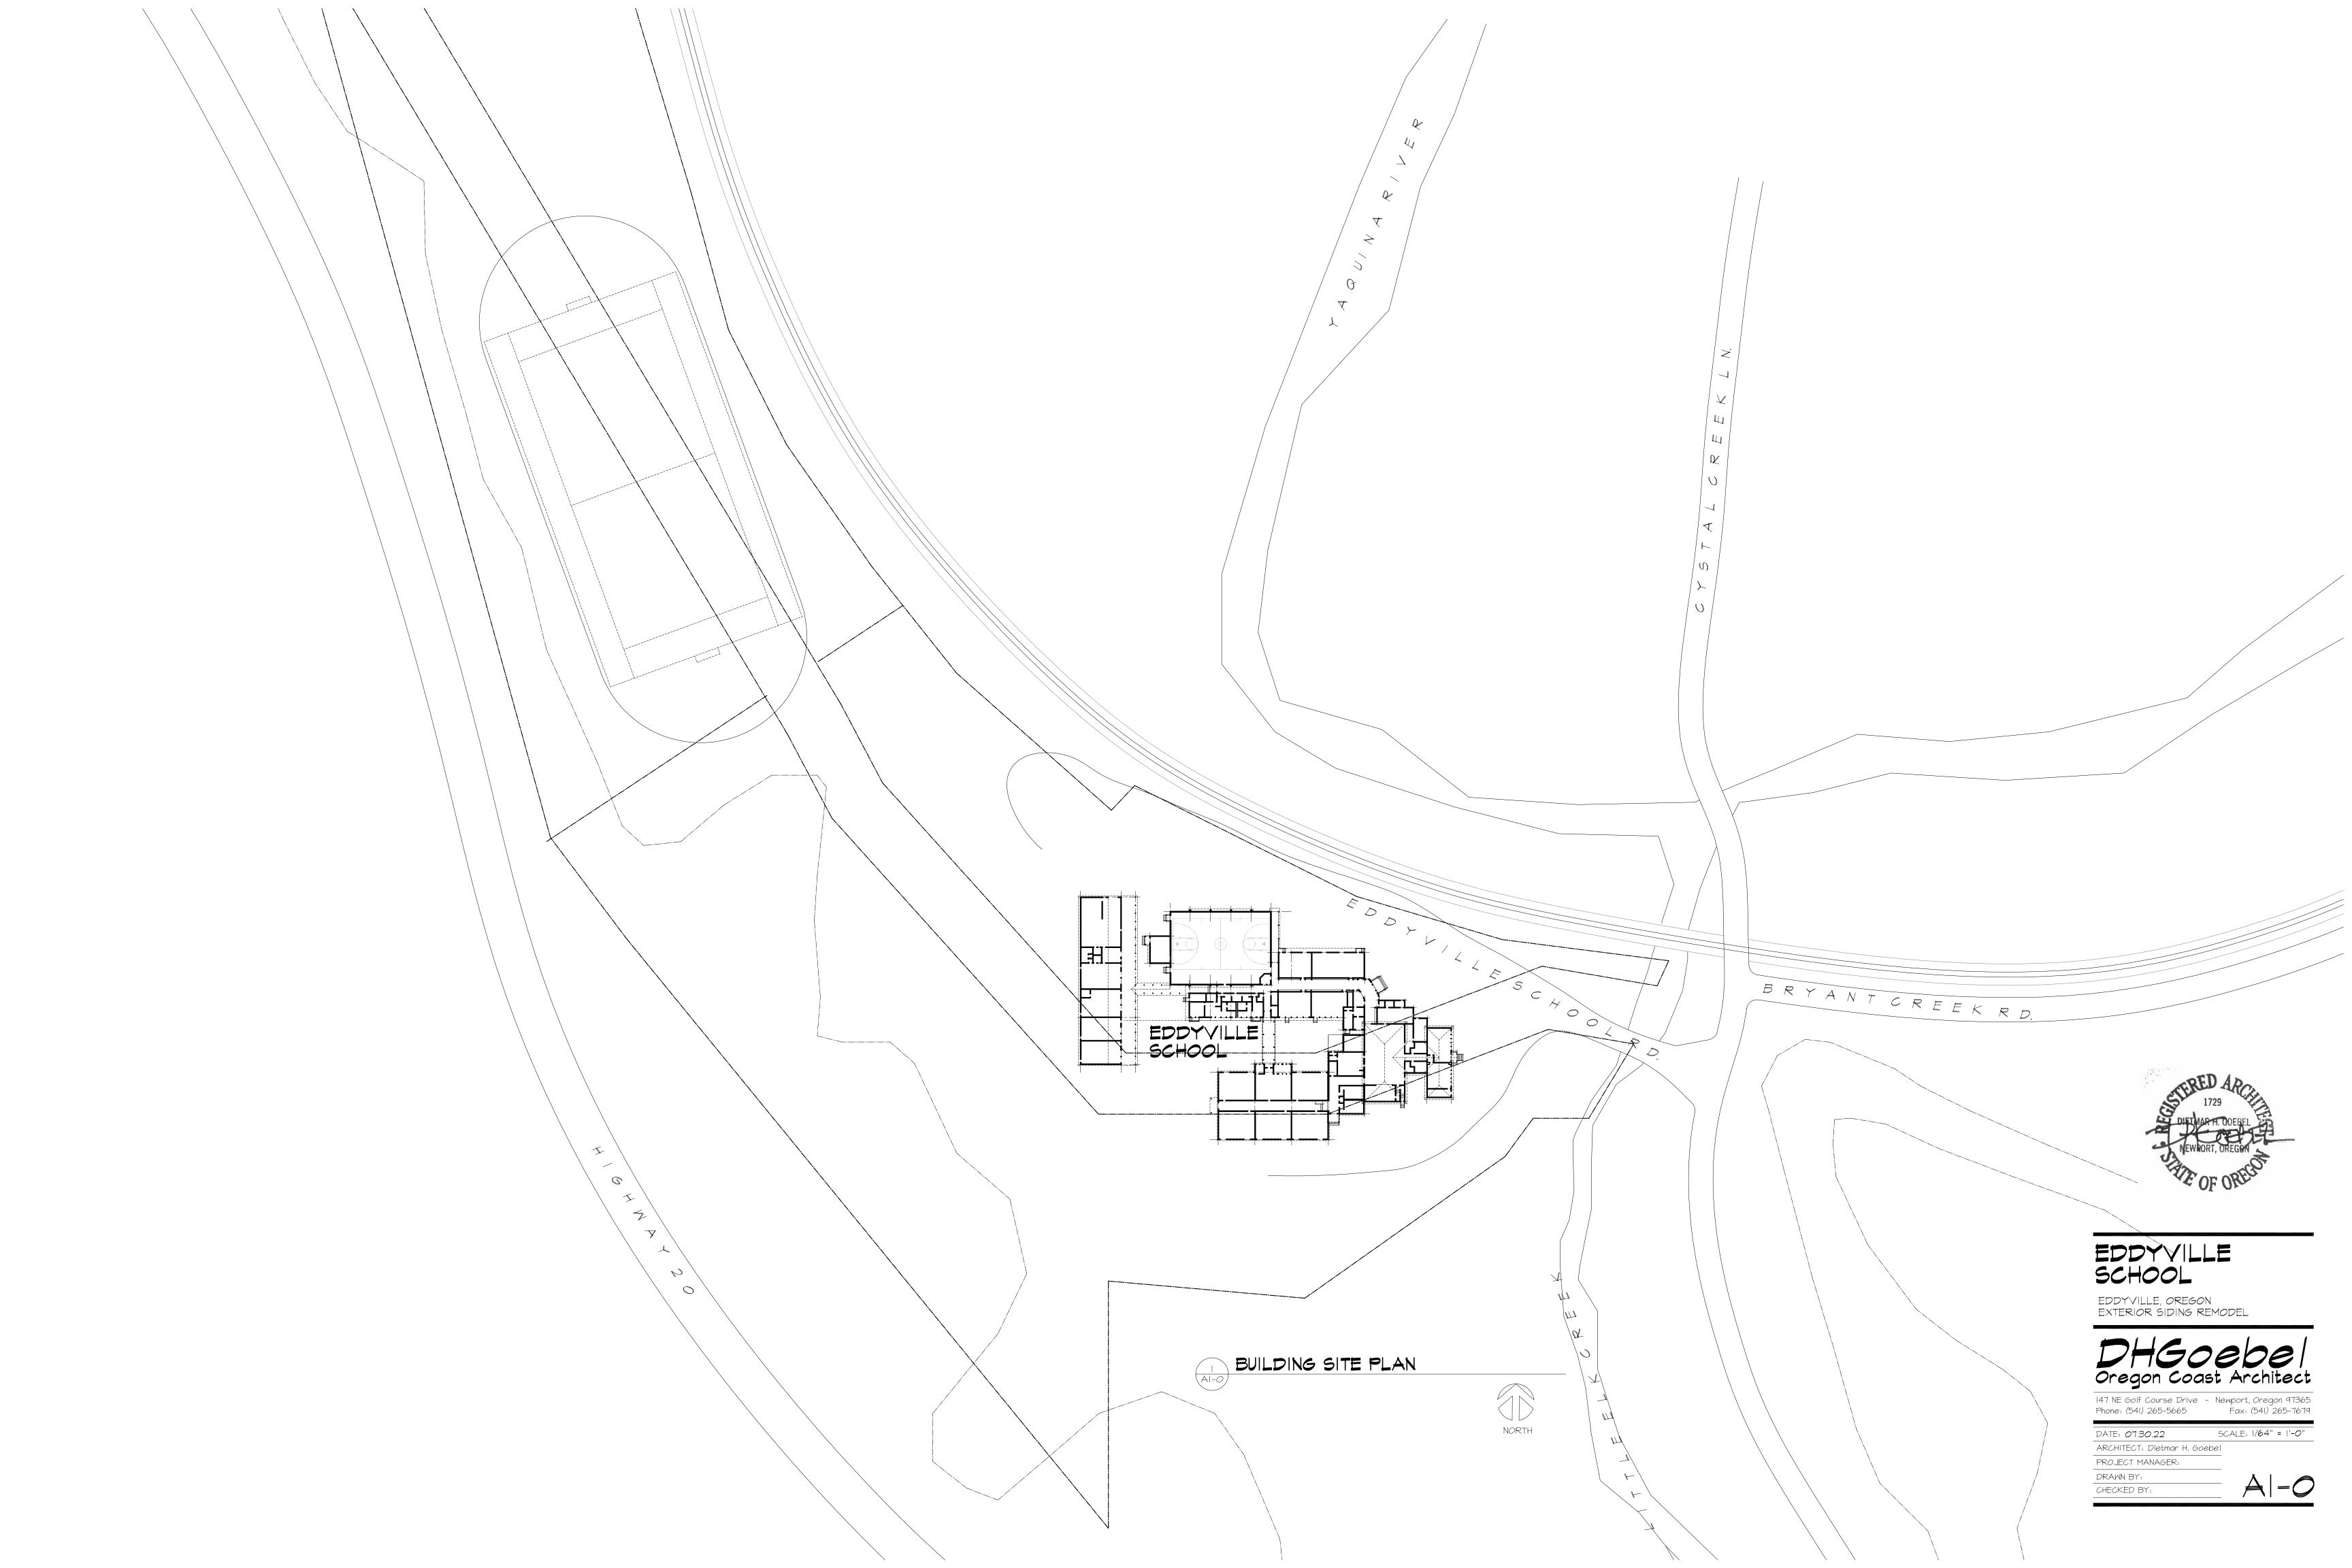

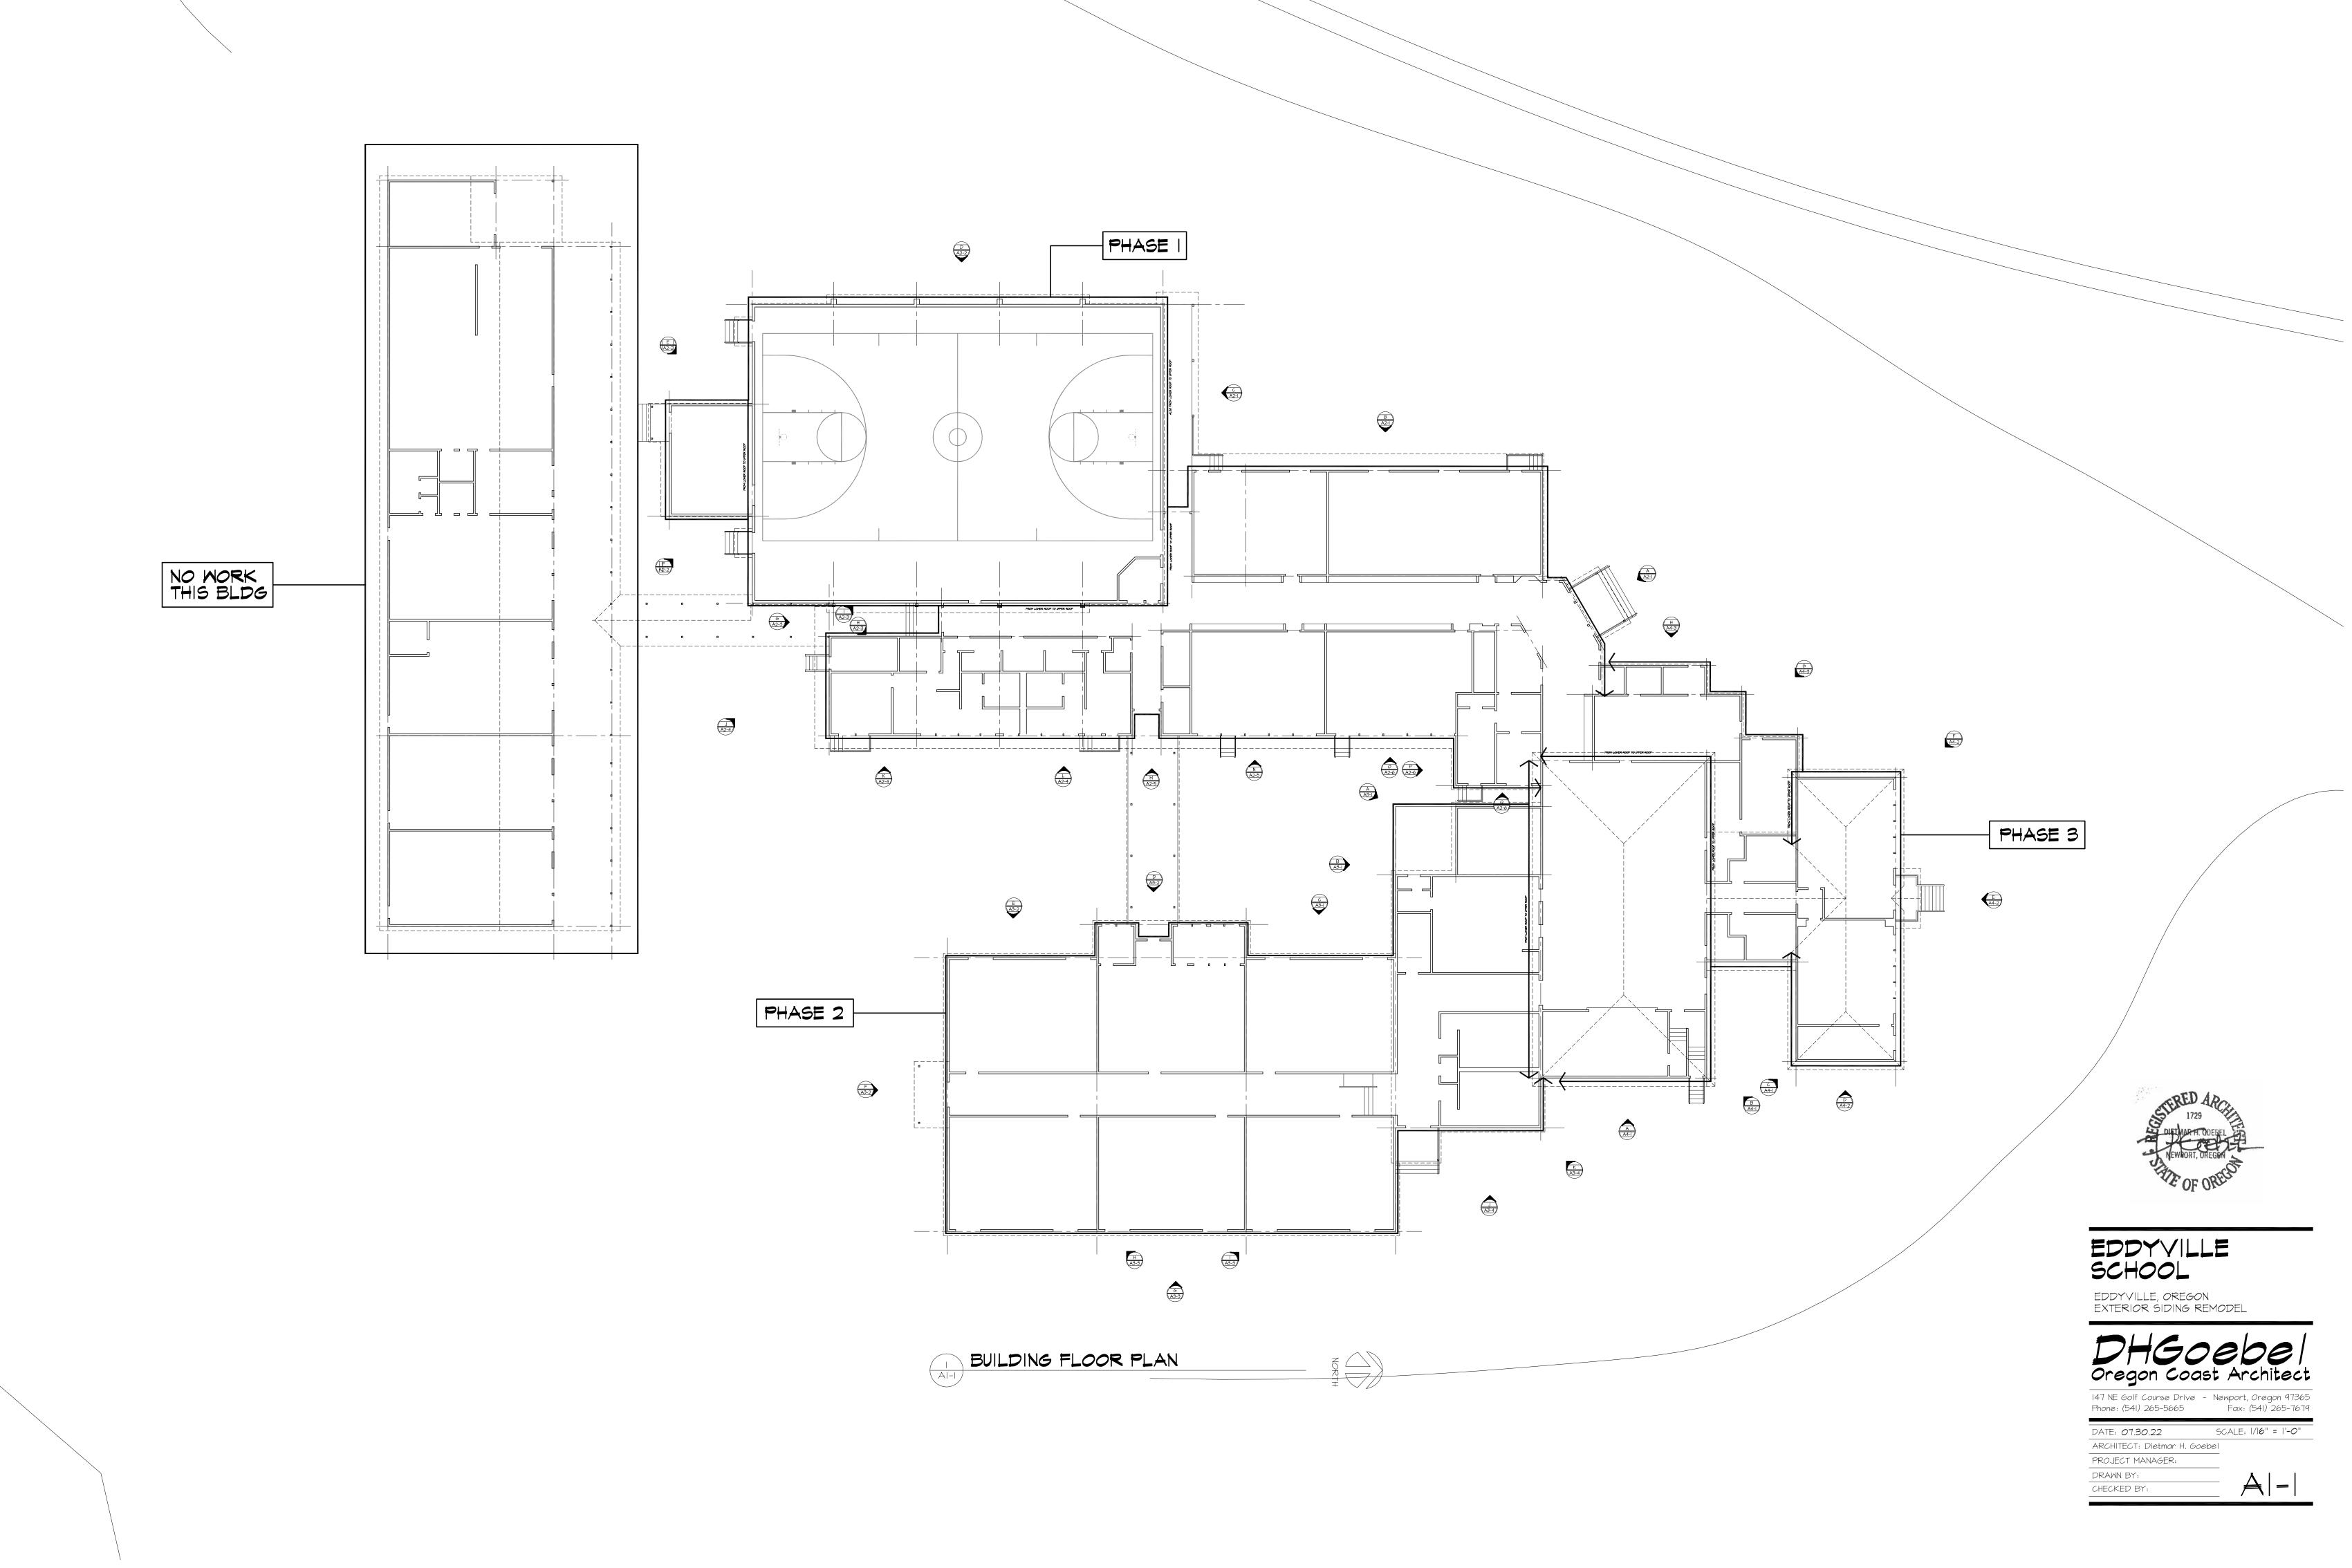







B





PRIOR TO ANY WORK STARTING, POWER WASH AREAS TO RECEIVE NEW SIDING, TRIM AND WINDOWS

- I. THE SCHOOL DISTRICT WILL COORDINATE WILL CONTRACTOR FOR REMOVAL OF CABLE OVER EXISTING SIDING AND OTHER ITEMS
- 2. INSPECT ALL EXISTING SIDING AND AREA FOR DRYROT AND WATER DAMAGE. REPAIR THESE AREA PRIOR TO INSALLATION OF NEW SIDING
- 3. REMOVE ALL CORNER BOARD AND WINDOW TRIM
- 4. REPLACEMENT OF WINDOWS: REMOVE THE ALUMINUM WINDWS AND REPLACE WITH SIMILAR UNITS IN VINYL WINDOWS TRIM OUT WINDOWS WITH 5/4X3.5 RUSTIC HARDIE TRIM
- 5. INSTALL KINGSPAN GREEN GUARD HOUSE WRAP AND DETAIL WRAP AROUND WINDOW PER MANUFACTURER'S RECOMMENDATION
- 6. INSTALL JAMES HARDIE PLANK SIDING, SELECT CEDARMILL, 7" TW
- 7. NEW CORNER BOARDS AND TRIM 5/4 X 3.5 RUSTIC HARDIE TRIM WINDOWS 5/4 X 3.5 HARDIE TRIM AROUND WINDOWS
- 8. ALL REQUIRED FLASHINGS TO BE GALVANIZED METAL
- 9. EXISTING ENTRY DOORS AND WINDOW UNITS TO REMAIN SEE NOTE ABOVE

PRIOR TO ANY WORK STARTING, POWER WASH AREAS TO RECEIVE NEW SIDING, TRIM AND WINDOWS

- I. THE SCHOOL DISTRICT WILL COORDINATE WILL CONTRACTOR FOR REMOVAL OF CABLE OVER EXISTING SIDING
- 2. INSPECT ALL EXISTING SIDING AND AREA FOR DRYROT AND WATER DAMAGE. REPAIR THESE AREA PRIOR TO INSALLATION OF NEW SIDING
- 3. REMOVE ALL CORNER BOARD
- 4. REPLACEMENT OF WINDOWS: IF THE WINDOW IS A VINYL WINDOW, IT WILL REMAIN WITH ANY TRIM REMOVED. IF THE WINDOW IS A WOOD WINDOW, REMOVE THE WINDOW AND TRIM AND INSTALL A NEW VINYL WINDOW WITH NEW TRIM. ALL EXITISNG VINYL WINDOWS WILL RECEIVE NEW WINDOW TRIM, WINDOW SIZE TO MATC H OPENING
- 5. INSTALL KINGSPAN GREEN GUARD HOUSE WRAP AND DETAIL WRAP AROUND WINDOW PER MANUFACTURER'S RECOMMENDATION
- 6. INSTALL JAMES HARDIE PLANK SIDING, SELECT CEDARMILL, 7" TW
- 7. NEW CORNER BOARDS AND TRIM 5/4 X 3.5 RUSTIC HARDIE TRIM WINDOWS 5/4 X 3.5 HARDIE TRIM AROUND WINDOWS
- 8. ALL REQUIRED FLASHINGS TO BE GALVANIZED STEEL METAL
- 9. SIDE OVER ABANDONED UNIT VENTILATOR GRILL, REMOVE GRILL AND FRAME IN AS NEEDED FOR SIDING, NEW 1/2" PLYWOOD SHTG.

PRIOR TO ANY WORK STARTING, POWER WASH AREAS TO RECEIVE NEW SIDING, TRIM AND WINDOWS

- I. THE SCHOOL DISTRICT WILL COORDINATE WITH CONTRACTOR FOR REMOVAL OF A.C UNIT PIPING AND EQUIPMENT, AND DISCONNECT SCHOOL DISTRICT TO REMOVE ANY AND ALL CONDUITS
- 2. INSPECT ALL EXISTING SIDING AND AREA FOR DRYROT AND WATER DAMAGE. REPAIR THESE AREA PRIOR TO INSALLATION OF NEW SIDING
- 3. REMOVE ALL CORNER TRIM BOARDS

METAL

- 4. INSTALL KINGSPAN GREEN GUARD HOUSE WRAP AND DETAIL WRAP AROUND WINDOW PER MANUFACTURER'S RECOMMENDATION
- 5. INSTALL JAMES HARDIE PLANK SIDING, SELECT CEDARMILL, 7" T.W.
- 6. NEW CORNER BOARDS AND TRIM 5/4 X 3.5 RUSTIC HARDIE TRIM
- 5/4 X 3.5 HARDIE TRIM AROUND NEW WINDOWS

 7. ALL REQUIRED FLASHINGS TO BE GALVANIZED
- 8. SIDING PROJECT TO INCLUDE ALL EXTERIOR WALLS OF THE GYM STRUCTURE, WALLS BETWEEN LOWER ROOF AND UPPER ROOF



EDDYVILLE SCHOOL

EDDYVILLE, OREGON EXTERIOR SIDING REMODEL

DHGOebel Oregon Coast Architect

A2-

Phone: (541) 265-5665 Fax: (541) 265-7679


DATE: 07.30.22 SCALE: 1/16" = 1'-0"

ARCHITECT: Dietmar H. Goebel
PROJECT MANAGER:
DRAWN BY:

CHECKED BY:

B



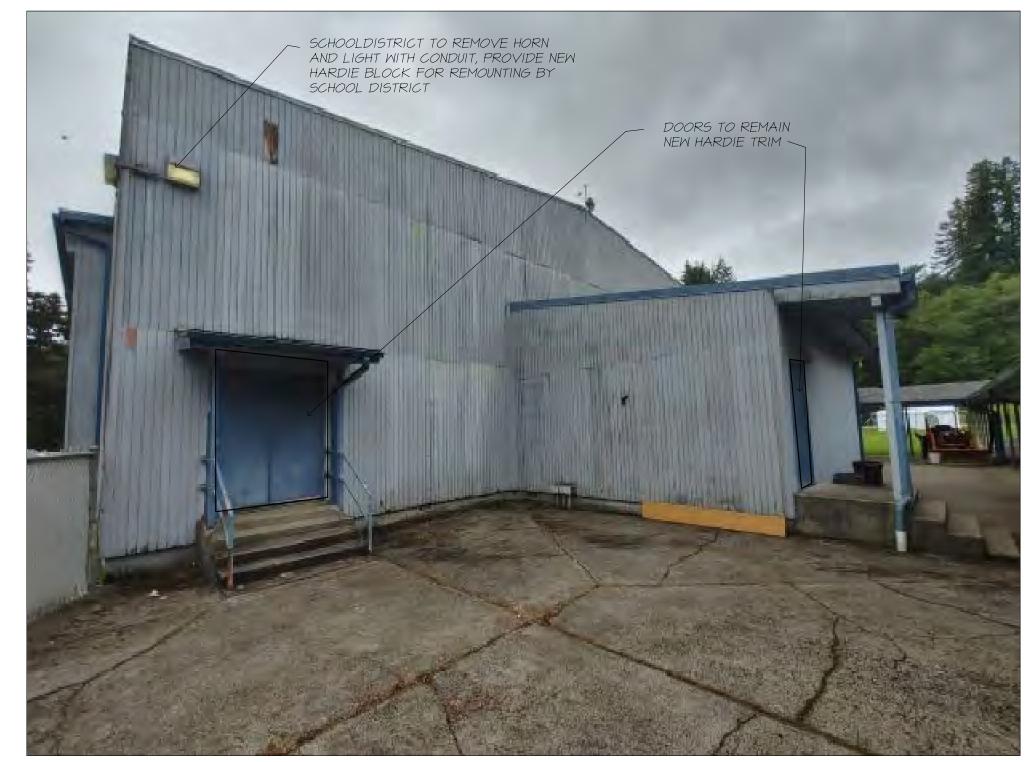









PRIOR TO ANY WORK STARTING, POWER WASH AREAS TO RECEIVE NEW SIDING, TRIM AND WINDOWS

- I. THE SCHOOL DISTRICT WILL COORDINATE WILL CONTRACTOR FOR REMOVAL OF CABLE OVER EXISTING SIDING AND OTHER ITEMS
- 2. INSPECT ALL EXISTING SIDING AND AREA FOR DRYROT AND WATER DAMAGE. REPAIR THESE AREA PRIOR TO INSALLATION OF NEW SIDING
- 3. REMOVE ALL CORNER BOARD
- 4. INSTALL KINGSPAN GREEN GUARD HOUSE WRAP AND DETAIL WRAP AROUND WINDOW PER MANUFACTURER'S RECOMMENDATION
- 5. ISSTALL JAMES HARDIE PLANK SIDING, SELECT CEDARMILL, 7" TW
- 6. NEW CORNER BOARDS AND TRIM 5/4 X 3.5 RUSTIC HARDIE TRIM WINDOWS 5/4 X 3.5 HARDIE TRIM AROUND WINDOWS
- 7.NEW ROOF/WALL REQUIRED FLASHINGS TO BE GALVANIZED METAL 8. REMOVE AND REINSTALL DOWNSPOUTS

PRIOR TO ANY WORK STARTING, POWER WASH AREAS TO RECEIVE NEW SIDING, TRIM AND WINDOWS

- I. THE SCHOOL DISTRICT WILL COORDINATE WILL CONTRACTOR FOR REMOVAL OF CABLE OVER EXISTING SIDING AND OTHER ITEMS
- 2. INSPECT ALL EXISTING SIDING AND AREA FOR DRYROT AND WATER DAMAGE. REPAIR THESE AREA PRIOR TO INSALLATION OF NEW SIDING
- 3. REMOVE ALL CORNER BOARD
- 4. INSTALL KINGSPAN GREEN GUARD HOUSE WRAP AND DETAIL WRAP AROUND WINDOW PER MANUFACTURER'S RECOMMENDATION
- 5. ISSTALL JAMES HARDIE PLANK SIDING, SELECT CEDARMILL, 7" TW
- 6. NEW CORNER BOARDS AND TRIM 5/4 X 3.5 RUSTIC HARDIE TRIM WINDOWS 5/4 X 3.5 HARDIE TRIM AROUND WINDOWS
- 7.NEW ROOF/WALL REQUIRED FLASHINGS TO BE GALVANIZED METAL 8. REMOVE AND REINSTALL DOWNSPOUTS

PRIOR TO ANY WORK STARTING, POWER WASH AREAS TO RECEIVE NEW SIDING, TRIM AND WINDOWS

- I. THE SCHOOL DISTRICT WILL COORDINATE WILL CONTRACTOR FOR REMOVAL OF CABLE OVER EXISTING SIDING AND OTHER ITEMS
- 2. INSPECT ALL EXISTING SIDING AND AREA FOR DRYROT AND WATER DAMAGE. REPAIR THESE AREA PRIOR TO INSALLATION OF NEW SIDING
- 3. REMOVE ALL CORNER BOARD
- 4. INSTALL KINGSPAN GREEN GUARD HOUSE WRAP AND DETAIL WRAP AROUND WINDOW PER MANUFACTURER'S RECOMMENDATION
- 5. ISSTALL JAMES HARDIE PLANK SIDING, SELECT CEDARMILL, 7" TW
- 6. NEW CORNER BOARDS AND TRIM 5/4 X 3.5 RUSTIC HARDIE TRIM WINDOWS 5/4 X 3.5 HARDIE TRIM AROUND WINDOWS
- T.NEW ROOF/WALL REQUIRED FLASHINGS TO BE GALVANIZED METAL
- 8. REMOVE AND REINSTALL DOWNSPOUTS
- 9. NEW SIDING ON WALLS BETWEEN LOWER AND UPPER ROOF OF GYM BUIDLING





EDDYVILLE, OREGON EXTERIOR SIDING REMODEL



| 147 NE Golf Course Drive - Newport, Oregon 97365 | Phone: (541) 265-5665 | Fax: (541) 265-7679

DATE: 07.30.22 SCALE: I/I6" = I'-0"

ARCHITECT: Dietmar H. Goebel

PROJECT MANAGER:

PROJECT MANAGER:


DRAWN BY:


CHECKED BY:







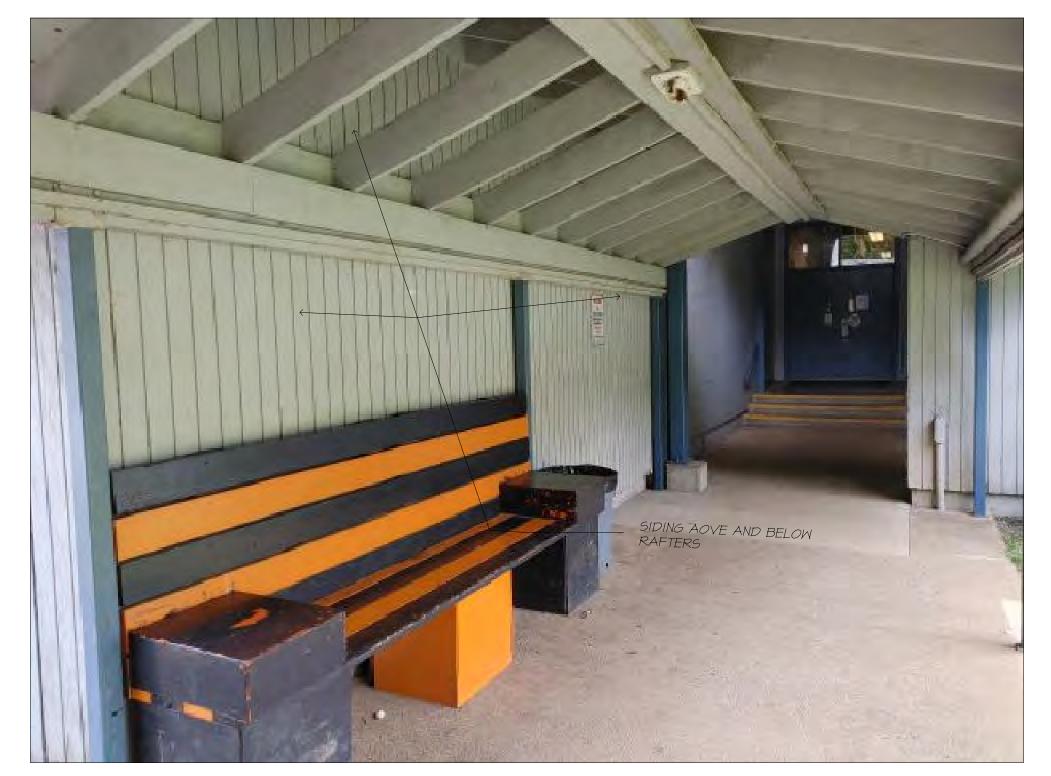

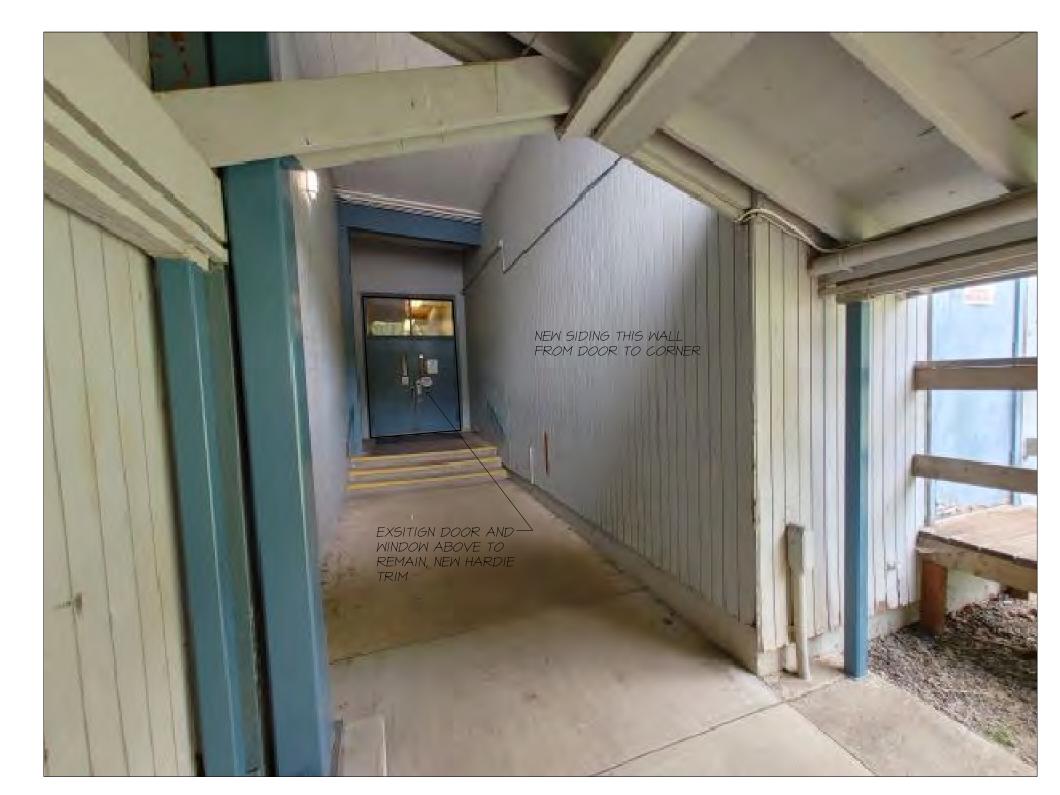







PRIOR TO ANY WORK STARTING, POWER WASH AREAS TO RECEIVE NEW SIDING, TRIM AND WINDOWS

- I. THE SCHOOL DISTRICT WILL COORDINATE WILL CONTRACTOR FOR REMOVAL OF BENCH ABD FURNITURE
- 2. INSPECT ALL EXISTING SIDING AND AREA FOR DRYROT AND WATER DAMAGE. REPAIR THESE AREA PRIOR TO INSALLATION OF NEW SIDING
- 3. REMOVE ALL CORNER BOARD
- 4. INSTALL KINGSPAN GREEN GUARD HOUSE WRAP AND DETAIL WRAP AROUND WINDOW PER MANUFACTURER'S RECOMMENDATION
- 5. ISSTALL JAMES HARDIE PLANK SIDING, SELECT CEDARMILL, 7" TW
- 6. NEW CORNER BOARDS AND TRIM 5/4 X 3.5 RUSTIC HARDIE TRIM WINDOWS 5/4 X 3.5 HARDIE TRIM AROUND WINDOWS
- 7.NEW ROOF/WALL REQUIRED FLASHINGS TO BE GALVANIZED METAL 8. SIDING ABOVE AND BELOW RAFTERS

PRIOR TO ANY WORK STARTING, POWER WASH AREAS TO RECEIVE NEW SIDING, TRIM AND WINDOWS

- I. THE SCHOOL DISTRICT WILL COORDINATE WILL CONTRACTOR FOR REMOVAL OF CABLE OVER EXISTING SIDING AND OTHER ITEMS
- 2. INSPECT ALL EXISTING SIDING AND AREA FOR DRYROT AND WATER DAMAGE. REPAIR THESE AREA PRIOR TO INSALLATION OF NEW SIDING
- 3. REMOVE ALL CORNER BOARD
- 4. INSTALL KINGSPAN GREEN GUARD HOUSE WRAP AND DETAIL WRAP AROUND WINDOW PER MANUFACTURER'S RECOMMENDATION
- 5. ISSTALL JAMES HARDIE PLANK SIDING, SELECT CEDARMILL, 7" TW
- 6. NEW CORNER BOARDS AND TRIM 5/4 X 3.5 RUSTIC HARDIE TRIM WINDOWS 5/4 X 3.5 HARDIE TRIM AROUND WINDOWS
- 7. SCHOOL DISTRICT TO LOOSEN ELECTRICAL CONDUIT FOR INSTALL IF SIDING AND THE RESECURE

PRIOR TO ANY WORK STARTING, POWER WASH AREAS TO RECEIVE NEW SIDING, TRIM AND WINDOWS

- I. THE SCHOOL DISTRICT WILL COORDINATE WILL CONTRACTOR FOR REMOVAL OF CABLE OVER EXISTING SIDING AND OTHER ITEMS
- 2. INSPECT ALL EXISTING SIDING AND AREA FOR DRYROT AND WATER DAMAGE. REPAIR THESE AREA PRIOR TO INSALLATION OF NEW SIDING
- 3. REMOVE ALL CORNER BOARDS AND TRIM
- 4. INSTALL KINGSPAN GREEN GUARD HOUSE WRAP AND DETAIL WRAP AROUND WINDOW PER MANUFACTURER'S RECOMMENDATION
- 5. ISSTALL JAMES HARDIE PLANK SIDING, SELECT CEDARMILL, 7" TW
- 6. NEW CORNER BOARDS AND TRIM 5/4 X 3.5 RUSTIC HARDIE TRIM WINDOWS 5/4 X 3.5 HARDIE TRIM AROUND WINDOWS



EDDYVILLE SCHOOL

EDDYVILLE, OREGON EXTERIOR SIDING REMODEL



 147 NE Golf Course Drive - Newport, Oregon 97365

 Phone: (541) 265-5665
 Fax: (541) 265-7679

DATE: 07.30.22 SCALE: I/I6" = I'-0"

ARCHITECT: Dietmar H. Goebel

PROJECT MANAGER:

PROJECT MANAGER:

DRAWN BY:

ANAGER:

Y:

A 2-3









PRIOR TO ANY WORK STARTING, POWER WASH AREAS TO RECEIVE NEW SIDING, TRIM AND WINDOWS

- I. THE SCHOOL DISTRICT WILL COORDINATE WILL CONTRACTOR FOR REMOVAL OF CABLE OVER EXISTING SIDING
- 2. INSPECT ALL EXISTING SIDING AND AREA FOR DRYROT AND WATER DAMAGE. REPAIR THESE AREA PRIOR TO INSALLATION OF NEW SIDING
- 3. REMOVE ALL CORNER BOARD
- 5. INSTALL KINGSPAN GREEN GUARD HOUSE WRAP AND DETAIL WRAP AROUND WINDOW PER MANUFACTURER'S RECOMMENDATION
- 6. INSTALL JAMES HARDIE PLANK SIDING, SELECT CEDARMILL, 7" TW
- 7. NEW CORNER BOARDS AND TRIM 5/4 X 3.5 RUSTIC HARDIE TRIM WINDOWS 5/4 X 3.5 HARDIE TRIM AROUND WINDOWS
- 8. ALL REQUIRED FLASHINGS TO BE GALVANIZED METAL
- 9. EXISTING HORN AND LIGHTS TO BE REMOVED AND REMOUNTED ON A NEW 5/4 HARDIE BLOCK AND FLASHED



PRIOR TO ANY WORK STARTING, POWER WASH AREAS TO RECEIVE NEW SIDING, TRIM AND WINDOWS

- I. THE SCHOOL DISTRICT WILL COORDINATE WILL CONTRACTOR FOR REMOVAL OF CABLE OVER EXISTING SIDING
- 2. INSPECT ALL EXISTING SIDING AND AREA FOR DRYROT AND WATER DAMAGE. REPAIR THESE AREA PRIOR TO INSALLATION OF NEW SIDING
- 3. REMOVE ALL CORNER BOARD
- 4. REPLACEMENT OF WINDOWS: IF THE WINDOW IS A VINYL WINDOW, IT WILL REMAIN WITH ANY TRIM REMOVED. IF THE WINDOW IS A WOOD WINDOW, REMOVE THE WINDOW AND TRIM AND INSTALL A NEE VINYL WINDOW WITH NEW TRIM. ALL EXITISNG VINYL WINDOWS WILL RECEIVE NEW WINDOW TRIM, WINDOW SIZE TO MATC H OPENING
- 5. INSTALL KINGSPAN GREEN GUARD HOUSE WRAP AND DETAIL WRAP AROUND WINDOW PER MANUFACTURER'S RECOMMENDATION
- 6. INSTALL JAMES HARDIE PLANK SIDING, SELECT CEDARMILL, 7" TW
- 7. NEW CORNER BOARDS AND TRIM 5/4 X 3.5 RUSTIC HARDIE TRIM WINDOWS 5/4 X 3.5 HARDIE TRIM AROUND WINDOWS
- 8. ALL REQUIRED FLASHINGS TO BE GALVANIZED METAL
- 9. EXISTING VENT TO BE REMOVED AND REMOUNTED ON A NEW 5/4 HARDIE BLOCK AND FLASHED
- 10. REMOVE EXISTING WINDOW UNITS AND INSTALL NEW SIDING
- II. REMOVE AND REPLACE EXISTING DOWNSPOUTS

PRIOR TO ANY WORK STARTING, POWER WASH AREAS TO RECEIVE NEW SIDING, TRIM AND WINDOWS

- I. THE SCHOOL DISTRICT WILL COORDINATE WILL CONTRACTOR FOR REMOVAL OF CABLE OVER EXISTING SIDING
- 2. INSPECT ALL EXISTING SIDING AND AREA FOR DRYROT AND WATER DAMAGE. REPAIR THESE AREA PRIOR TO INSALLATION OF NEW SIDING
- 3. REMOVE ALL CORNER BOARD
- 4. REPLACEMENT OF WINDOWS: IF THE WINDOW IS A VINYL WINDOW, IT WILL REMAIN WITH ANY TRIM REMOVED. IF THE WINDOW IS A WOOD WINDOW, REMOVE THE WINDOW AND TRIM AND INSTALL A NEE VINYL WINDOW WITH NEW TRIM. ALL EXITISNG VINYL WINDOWS WILL RECEIVE NEW WINDOW TRIM, WINDOW SIZE TO MATC H OPENING
- 5. INSTALL KINGSPAN GREEN GUARD HOUSE WRAP AND DETAIL WRAP AROUND WINDOW PER MANUFACTURER'S RECOMMENDATION
- 6. INSTALL JAMES HARDIE PLANK SIDING, SELECT CEDARMILL, 7" TW
- 7. NEW CORNER BOARDS AND TRIM 5/4 X 3.5 RUSTIC HARDIE TRIM WINDOWS 5/4 X 3.5 HARDIE TRIM AROUND WINDOWS
- 8. ALL REQUIRED FLASHINGS TO BE GALVANIZED METAL
- 9. EXISTING VENT TO BE REMOVED AND REMOUNTED ON A NEW 5/4 HARDIE BLOCK AND FLASHED
- IO. REMOVE EXISTING WINDOW UNITS AND INSTALL NEW SIDING
- II. REMOVE AND REPLACE EXISTING DOWNSPOUTS

EDDYVILLE SCHOOL

EDDYVILLE, OREGON EXTERIOR SIDING REMODEL



147 NE Golf Course Drive - Newport, Oregon 97365
Phone: (541) 265-5665 Fax: (541) 265-7679

DATE: 07.30.22 SCALE: |/|6" = |'-0"

ARCHITECT: Dietmar H. Goebel

PROJECT MANAGER:
DRAWN BY:


AGER: **A**2-4










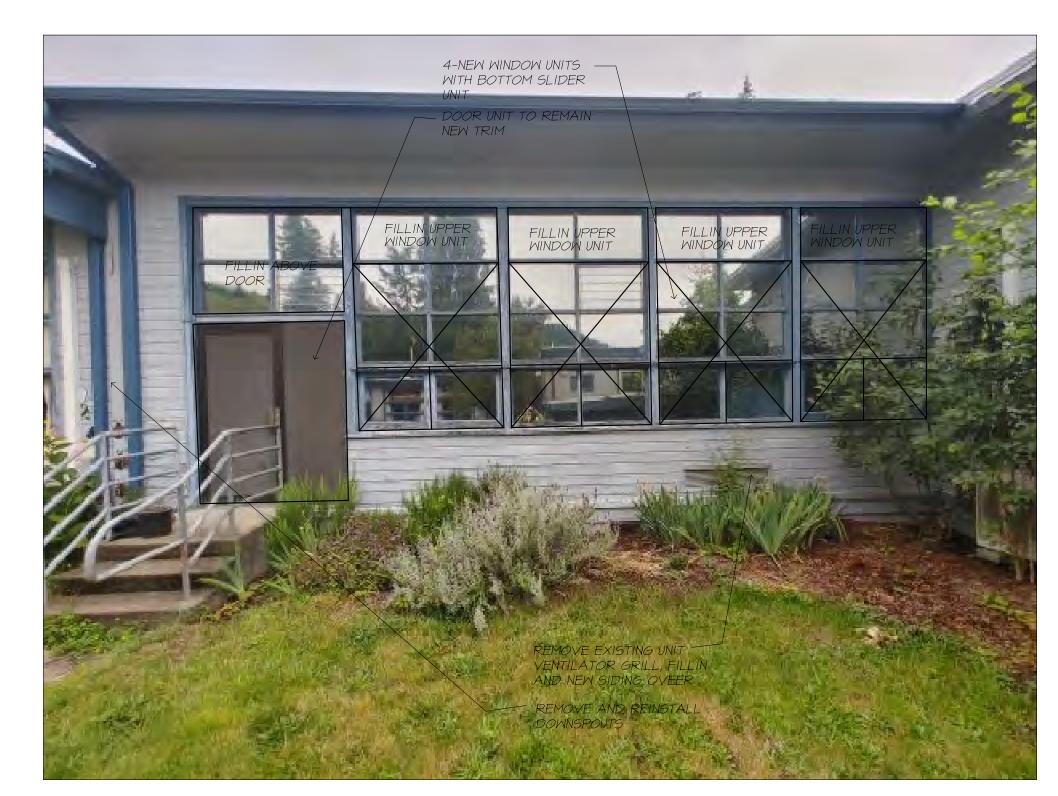

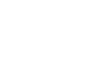







RECEIVE NEW SIDING, TRIM AND WINDOWS

- I. THE SCHOOL DISTRICT WILL COORDINATE WILL CONTRACTOR FOR REMOVAL OF CABLE OVER EXISTING SIDING
- 2 INSPECT ALL EXISTING SIDING AND AREA FOR DRYROT AND WATER DAMAGE. REPAIR THESE AREA PRIOR TO INSALLATION OF NEW SIDING
- 3. REMOVE ALL CORNER BOARD
- 5. INSTALL KINGSPAN GREEN GUARD HOUSE WRAP AND DETAIL WRAP AROUND WINDOW PER MANUFACTURER'S RECOMMENDATION
- 6. INSTALL JAMES HARDIE PLANK SIDING, SELECT CEDARMILL, 7" TW
- 7. NEW CORNER BOARDS AND TRIM 5/4 X 3.5 RUSTIC HARDIE TRIM WINDOWS - 5/4 X 3.5 HARDIE TRIM AROUND WINDOWS
- 8. ALL REQUIRED FLASHINGS TO BE GALVANIZED METAL
- 9. EXISTING LIGHTS TO BE REMOVED AND REMOUNTED ON A NEW 5/4 HARDIE BLOCK AND FLASHED



RECEIVE NEW SIDING, TRIM AND WINDOWS

- I. THE SCHOOL DISTRICT WILL COORDINATE WILL CONTRACTOR FOR REMOVAL OF CABLE OVER EXISTING SIDING
- 2. INSPECT ALL EXISTING SIDING AND AREA FOR DRYROT AND WATER DAMAGE. REPAIR THESE AREA PRIOR TO INSALLATION OF NEW SIDING
- 3. REMOVE ALL CORNER BOARD
- 4. REPLACEMENT OF WINDOWS: IF THE WINDOW IS A VINYL WINDOW, IT WILL REMAIN WITH ANY TRIM REMOVED. IF THE WINDOW IS A WOOD WINDOW, REMOVE THE WINDOW AND TRIM AND INSTALL A NEW VINYL WINDOW WITH NEW TRIM. ALL EXITING VINYL WINDOWS WILL RECEIVE NEW WINDOW TRIM, WINDOW SIZE TO MATC H OPENING
- 5. INSTALL KINGSPAN GREEN GUARD HOUSE WRAP AND DETAIL WRAP AROUND WINDOW PER MANUFACTURER'S RECOMMENDATION
- 6. INSTALL JAMES HARDIE PLANK SIDING, SELECT CEDARMILL, 7" TW
- 7. NEW CORNER BOARDS AND TRIM 5/4 X 3.5 RUSTIC HARDIE TRIM WINDOWS - 5/4 X 3.5 HARDIE TRIM AROUND WINDOWS
- 8. ALL REQUIRED FLASHINGS TO BE GALVANIZED METAL
- 9. EXISTING VENT TO BE REMOVED AND FILLED IN NEW HARDIE SIDING OVER
- 10. REMOVE EXISTING WINDOW UNITS AND INSTALL NEW SIDING WHERE INDICATED
- II. REMOVE AND REPLACE EXISTING DOWNSPOUTS

RECEIVE NEW SIDING, TRIM AND WINDOWS

- I. THE SCHOOL DISTRICT WILL COORDINATE WILL CONTRACTOR FOR REMOVAL OF CABLE OVER EXISTING SIDING
- 2 INSPECT ALL EXISTING SIDING AND AREA FOR DRYROT AND WATER DAMAGE. REPAIR THESE AREA PRIOR TO INSALLATION OF NEW SIDING
- 3. REMOVE ALL CORNER BOARD
- 4. REPLACEMENT OF WINDOWS: IF THE WINDOW IS A VINYL WINDOW, IT WILL REMAIN WITH ANY TRIM REMOVED. IF THE WINDOW IS A WOOD WINDOW, REMOVE THE WINDOW AND TRIM AND INSTALL A NEE VINYL WINDOW WITH NEW TRIM. ALL EXITISNG VINYL WINDOWS WILL RECEIVE NEW WINDOW TRIM, WINDOW SIZE TO MATC H OPENING
- 5. INSTALL KINGSPAN GREEN GUARD HOUSE WRAP AND DETAIL WRAP AROUND WINDOW PER MANUFACTURER'S RECOMMENDATION
- 6. INSTALL JAMES HARDIE PLANK SIDING, SELECT CEDARMILL, 7" TW
- 7. NEW CORNER BOARDS AND TRIM 5/4 X 3.5 RUSTIC HARDIE TRIM WINDOWS - 5/4 X 3.5 HARDIE TRIM AROUND WINDOWS
- 8. ALL REQUIRED FLASHINGS TO BE GALVANIZED METAL
- 9. EXISTING VENT TO BE REMOVED AND FILLED IN NEDWS HARDIE SIDING OVER
- 10. REMOVE EXISTING WINDOW UNITS AND INSTALL NEW SIDING WHERE INDICAATED
- II. REMOVE AND REPLACE EXISTING DOWNSPOUTS

EDDYVILLE SCHOOL

EDDYVILLE, OREGON EXTERIOR SIDING REMODEL



Phone: (541) 265-5665 Fax: (541) 265-7679

DATE: 07.30.22 SCALE: 1/16" = 1'-0" ARCHITECT: Dietmar H. Goebel

PROJECT MANAGER: DRAWN BY:













PRIOR TO ANY WORK STARTING, POWER WASH AREAS TO RECEIVE NEW SIDING, TRIM AND WINDOWS

- I. THE SCHOOL DISTRICT WILL COORDINATE WILL CONTRACTOR FOR REMOVAL OF CABLE OVER EXISTING SIDING
- 2. INSPECT ALL EXISTING SIDING AND AREA FOR DRYROT AND WATER DAMAGE. REPAIR THESE AREA PRIOR TO INSALLATION OF NEW SIDING
- 3. REMOVE ALL CORNER BOARD
- 4. REPLACEMENT OF WINDOWS: IF THE WINDOW IS A VINYL WINDOW, IT WILL REMAIN WITH ANY TRIM REMOVED. IF THE WINDOW IS A WOOD WINDOW, REMOVE THE WINDOW AND TRIM AND INSTALL A NEW VINYL WINDOW WITH NEW TRIM. ALL EXITING VINYL WINDOWS WILL RECEIVE NEW WINDOW TRIM, WINDOW SIZE TO MATC H OPENING
- 5. INSTALL KINGSPAN GREEN GUARD HOUSE WRAP AND DETAIL WRAP AROUND WINDOW PER MANUFACTURER'S RECOMMENDATION
- 6. INSTALL JAMES HARDIE PLANK SIDING, SELECT CEDARMILL, 7" TW
- 7. NEW CORNER BOARDS AND TRIM 5/4 X 3.5 RUSTIC HARDIE TRIM WINDOWS 5/4 X 3.5 HARDIE TRIM AROUND WINDOWS
- 8. ALL REQUIRED FLASHINGS TO BE GALVANIZED METAL
- 9. EXISTING VENT TO BE REMOVED AND REINSTALLED ON NEW HARDIE BLOCK

PRIOR TO ANY WORK STARTING, POWER WASH AREAS TO RECEIVE NEW SIDING, TRIM AND WINDOWS

- I. THE SCHOOL DISTRICT WILL COORDINATE WILL CONTRACTOR FOR REMOVAL OF CABLE OVER EXISTING SIDING
- 2. INSPECT ALL EXISTING SIDING AND AREA FOR DRYROT AND WATER DAMAGE. REPAIR THESE AREA PRIOR TO INSALLATION OF NEW SIDING
- 3. REMOVE ALL CORNER BOARD
- 4. REPLACEMENT OF WINDOWS: IF THE WINDOW IS A VINYL WINDOW, IT WILL REMAIN WITH ANY TRIM REMOVED. IF THE WINDOW IS A WOOD WINDOW, REMOVE THE WINDOW AND TRIM AND INSTALL A NEW VINYL WINDOW WITH NEW TRIM. ALL EXITING VINYL WINDOWS WILL RECEIVE NEW WINDOW TRIM, WINDOW SIZE TO MATC H OPENING
- 5. INSTALL KINGSPAN GREEN GUARD HOUSE WRAP AND DETAIL WRAP AROUND WINDOW PER MANUFACTURER'S RECOMMENDATION
- 6. INSTALL JAMES HARDIE PLANK SIDING, SELECT CEDARMILL, 7" TW
- 7. NEW CORNER BOARDS AND TRIM 5/4 X 3.5 RUSTIC HARDIE TRIM WINDOWS 5/4 X 3.5 HARDIE TRIM AROUND WINDOWS
- 8. ALL REQUIRED FLASHINGS TO BE GALVANIZED METAL
- 9. EXISTING VENT TO BE REMOVED AND REINSTALLED WITH NEW HARDIE BLOCK
- IO. REMOVE EXISTING WINDOW UNITS AND INSTALL NEW SIDING WHERE INDICATED
- II. REMOVE AND REPLACE EXISTING DOWNSPOUTS







DATE: 07.30.22 SCALE: 1/16" = 1'-0"

DATE: 07.30.22 SC ARCHITECT: Dietmar H. Goebel PROJECT MANAGER:

EDDYVILLE

EDDYVILLE, OREGON EXTERIOR SIDING REMODEL

SCHOOL

DRAWN BY:











RECEIVE NEW SIDING, TRIM AND WINDOWS

- I. THE SCHOOL DISTRICT WILL COORDINATE WILL CONTRACTOR FOR REMOVAL OF CABLE OVER EXISTING SIDING
- 2 INSPECT ALL EXISTING SIDING AND AREA FOR DRYROT AND WATER DAMAGE. REPAIR THESE AREA PRIOR TO INSALLATION OF NEW SIDING
- 3. REMOVE ALL CORNER BOARD
- 4. REPLACEMENT OF WINDOWS: IF THE WINDOW IS A VINYL WINDOW, IT WILL REMAIN WITH ANY TRIM REMOVED. IF THE WINDOW IS A WOOD WINDOW, REMOVE THE WINDOW AND TRIM AND INSTALL A NEE VINYL WINDOW WITH NEW TRIM. ALL EXITISNG VINYL WINDOWS WILL RECEIVE NEW WINDOW TRIM, WINDOW SIZE TO MATC H OPENING
- 5. INSTALL KINGSPAN GREEN GUARD HOUSE WRAP AND DETAIL WRAP AROUND WINDOW PER MANUFACTURER'S RECOMMENDATION
- 6. INSTALL JAMES HARDIE PLANK SIDING, SELECT CEDARMILL, 7" TW
- 7. NEW CORNER BOARDS AND TRIM 5/4 X 3.5 RUSTIC HARDIE TRIM WINDOWS - 5/4 X 3.5 HARDIE TRIM AROUND WINDOWS
- 8. ALL REQUIRED FLASHINGS TO BE GALVANIZED METAL
- 9. EXISTING VENT HOODS TO BE REMOVED AND REMOUNTED ON A NEW 5/4 HARDIE BLOCK AND FLASHED

RECEIVE NEW SIDING, TRIM AND WINDOWS

- I. THE SCHOOL DISTRICT WILL COORDINATE WILL CONTRACTOR FOR REMOVAL OF CABLE OVER EXISTING SIDING
- 2. INSPECT ALL EXISTING SIDING AND AREA FOR DRYROT AND WATER DAMAGE. REPAIR THESE AREA PRIOR TO INSALLATION OF NEW SIDING
- 3. REMOVE ALL CORNER BOARD
- 4. REPLACEMENT OF WINDOWS: IF THE WINDOW IS A VINYL WINDOW, IT WILL REMAIN WITH ANY TRIM REMOVED. IF THE WINDOW IS A WOOD WINDOW, REMOVE THE WINDOW AND TRIM AND INSTALL A NEW VINYL WINDOW WITH NEW TRIM. ALL EXITISNG VINYL WINDOWS WILL RECEIVE NEW WINDOW TRIM, WINDOW SIZE TO MATC H OPENING
- 5. INSTALL KINGSPAN GREEN GUARD HOUSE WRAP AND DETAIL WRAP AROUND WINDOW PER MANUFACTURER'S RECOMMENDATION
- 6. INSTALL JAMES HARDIE PLANK SIDING, SELECT CEDARMILL, 7" TW
- 7. NEW CORNER BOARDS AND TRIM 5/4 X 3.5 RUSTIC HARDIE TRIM WINDOWS - 5/4 X 3.5 HARDIE TRIM AROUND WINDOWS
- 8. ALL REQUIRED FLASHINGS TO BE GALVANIZED STEEL METAL



RECEIVE NEW SIDING, TRIM AND WINDOWS

- I. THE SCHOOL DISTRICT WILL COORDINATE WITH CONTRACTOR FOR REMOVAL OF A.C UNIT PIPING AND EQUIPMENT, AND DISCONNECT SCHOOL DISTRICT TO REMOVE ANY AND ALL CONDUITS
- 2 INSPECT ALL EXISTING SIDING AND AREA FOR DRYROT AND WATER DAMAGE. REPAIR THESE AREA PRIOR TO INSALLATION OF NEW SIDING
- 3. REMOVE ALL TRIM BOARDS
- 4. REMOVE WOOD WINDOWS INSTALL 3 NEW VINYL WINDOWS WITH BOTTOM VENTED UNIT - WINDOW TO FIT ALL 6 EXISTING WINDOW UNITS.
- 5. EXISTING DOOR TO REMAIN REMOVE TRIM AND NEW 5/4X3.5 HARDIE TRIM. SIDE OVER WINDOW UNIT ABOVE DOOR
- 6. SIDE OVER ABANDONED UNIT VENTILATOR GRILL, REMOVE GRILL AND FRAME IN AS NEEDED FOR SIDING, NEW 1/2" PLYWOOD SHTG.
- 7. INSTALL KINGSPAN GREEN GUARD HOUSE WRAP AND DETAIL WRAP AROUND WINDOW PER MANUFACTURER'S RECOMMENDATION
- 8. INSTALL JAMES HARDIE PLANK SIDING, SELECT CEDARMILL, 7" T.M.
- 9. NEW CORNER BOARDS AND TRIM 5/4 X 3.5 RUSTIC HARDIE TRIM
- 5/4 X 3.5 HARDIE TRIM AROUND NEW WINDOWS
- 10. ALL REQUIRED FLASHINGS TO BE GALVANIZED METAL

EDDYVILLE SCHOOL

EDDYVILLE, OREGON EXTERIOR SIDING REMODEL



Phone: (541) 265-5665 Fax: (541) 265-7679

A3-

DATE: 07.30.22 SCALE: 1/4" = 1'-0" ARCHITECT: Dietmar H. Goebel

PROJECT MANAGER: DRAWN BY: CHECKED BY:



















PRIOR TO ANY WORK STARTING, POWER WASH AREAS TO RECEIVE NEW SIDING, TRIM AND WINDOWS

- I. THE SCHOOL DISTRICT WILL COORDINATE WITH CONTRACTOR FOR REMOVAL OF A.C UNIT PIPING AND EQUIPMENT, AND DISCONNECT SCHOOL DISTRICT TO REMOVE ANY AND ALL CONDUITS
- 2. INSPECT ALL EXISTING SIDING AND AREA FOR DRYROT AND WATER DAMAGE. REPAIR THESE AREA PRIOR TO INSALLATION OF NEW SIDING
- 3. REMOVE ALL TRIM BOARDS
- 4. REMOVE WOOD WINDOWS
- BOTTOM VENTED UNIT WINDOW TO FIT ALL 6 EXISTING WINDOW UNITS.
- 5. EXISTING DOOR TO REMAIN REMOVE TRIM AND NEW 5/4X3.5 HARDIE TRIM. SIDE OVER WINDOW UNIT ABOVE DOOR
- 6. SIDE OVER ABANDONED UNIT VENTILATOR GRILL, REMOVE GRILL AND FRAME IN AS NEEDED FOR SIDING, NEW 1/2" PLYWOOD SHTG.
- 7. INSTALL KINGSPAN GREEN GUARD HOUSE WRAP AND DETAIL WRAP AROUND WINDOW PER MANUFACTURER'S RECOMMENDATION
- 8. INSTALL JAMES HARDIE PLANK SIDING, SELECT CEDARMILL, 7" T.W.
- 9. NEW CORNER BOARDS AND TRIM 5/4 X 3.5 RUSTIC HARDIE TRIM
- 5/4 X 3.5 HARDIE TRIM AROUND NEW WINDOWS
- IO. ALL REQUIRED FLASHINGS TO BE GALVANIZED METAL

PRIOR TO ANY WORK STARTING, POWER WASH AREAS TO RECEIVE NEW SIDING, TRIM AND WINDOWS

1. NO CHANGE THIS WALL

PRIOR TO ANY WORK STARTING, POWER WASH AREAS TO RECEIVE NEW SIDING, TRIM AND WINDOWS

I. NO CHANGE THIS WALL



EDDYVILLE SCHOOL

EDDYVILLE, OREGON EXTERIOR SIDING REMODEL

DHGOebel Oregon Coast Architect

| 147 NE Golf Course Drive - Newport, Oregon 97365 | Phone: (541) 265-5665 | Fax: (541) 265-7679

A3-2

DATE: 07.30.22 SCALE: 1/4" = 1'-0"

ARCHITECT: Dietmar H. Goebel

PROJECT MANAGER.

PROJECT MANAGER:

DRAWN BY:

CHECKED BY:












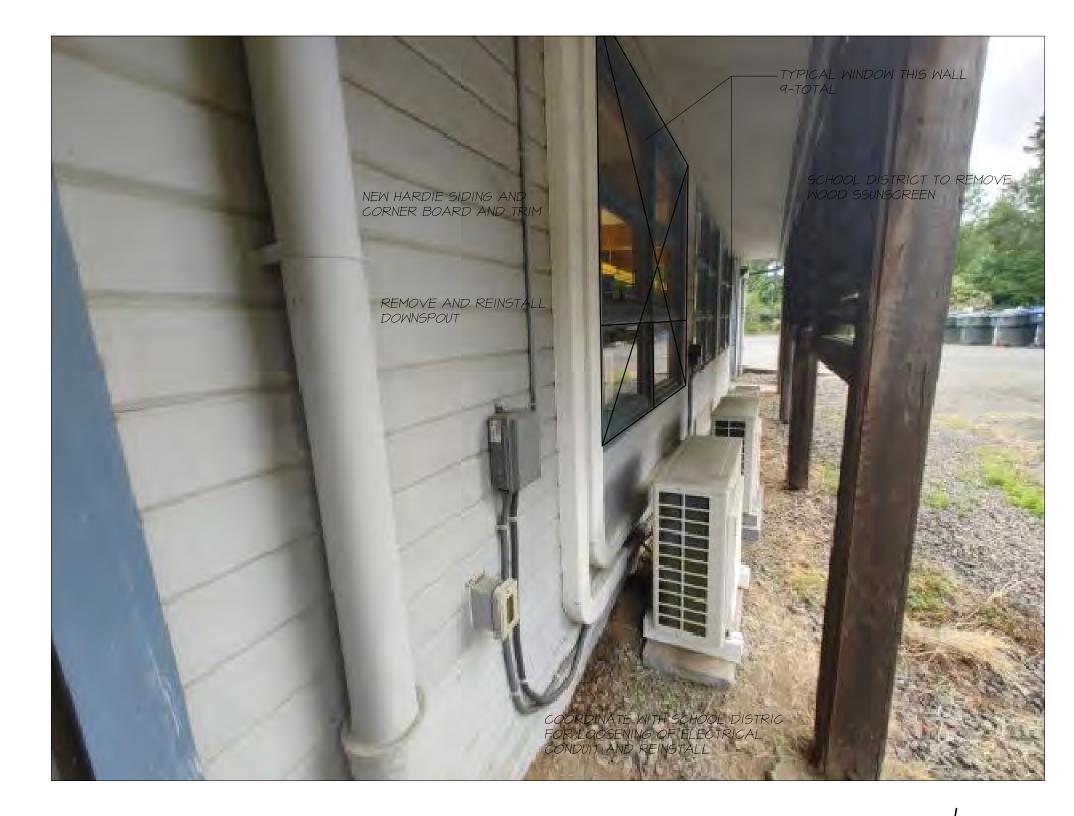





RECEIVE NEW SIDING, TRIM AND WINDOWS

- I. THE SCHOOL DISTRICT WILL COORDINATE WILL CONTRACTOR FOR REMOVAL OF CABLE OVER EXISTING SIDING
- 2. INSPECT ALL EXISTING SIDING AND AREA FOR DRYROT AND WATER DAMAGE. REPAIR THESE AREA PRIOR TO INSALLATION OF NEW SIDING
- 3. REMOVE ALL CORNER BOARD
- 4. REPLACEMENT OF WINDOWS: IF THE WINDOW IS A VINYL WINDOW. IT WILL REMAIN WITH ANY TRIM REMOVED. IF THE WINDOW IS A WOOD WINDOW, REMOVE THE WINDOW AND TRIM AND INSTALL A NEE VINYL WINDOW WITH NEW TRIM. ALL EXITISNG VINYL WINDOWS WILL RECEIVE NEW WINDOW TRIM, WINDOW SIZE TO MATC H OPENING
- 5. INSTALL KINGSPAN GREEN GUARD HOUSE WRAP AND DETAIL WRAP AROUND WINDOW PER MANUFACTURER'S RECOMMENDATION
- 6. INSTALL JAMES HARDIE PLANK SIDING, SELECT CEDARMILL, 7" TW
- 7. NEW CORNER BOARDS AND TRIM 5/4 X 3.5 RUSTIC HARDIE TRIM WINDOWS - 5/4 X 3.5 HARDIE TRIM AROUND WINDOWS
- 8. ALL REQUIRED FLASHINGS TO BE GALVANIZED METAL
- 9. EXISTING VENT HOODS TO BE REMOVED AND REMOUNTED ON
- A NEW 5/4 HARDIE BLOCK AND FLASHED
- IO SCHOOL DISTRICT WILL REMOVE WOODEN SUNSCREEN

RECEIVE NEW SIDING, TRIM AND WINDOWS

- I. THE SCHOOL DISTRICT WILL COORDINATE WILL CONTRACTOR FOR REMOVAL OF CABLE OVER EXISTING SIDING
- 2 INSPECT ALL EXISTING SIDING AND AREA FOR DRYROT AND WATER DAMAGE. REPAIR THESE AREA PRIOR TO INSALLATION OF NEW SIDING
- 3. REMOVE ALL CORNER BOARD
- 4. REPLACEMENT OF WINDOWS: IF THE WINDOW IS A VINYL WINDOW, IT WILL REMAIN WITH ANY TRIM REMOVED. IF THE WINDOW IS A WOOD WINDOW, REMOVE THE WINDOW AND TRIM AND INSTALL A NEW VINYL WINDOW WITH NEW TRIM. ALL EXITISNG VINYL WINDOWS WILL RECEIVE NEW WINDOW TRIM, WINDOW SIZE TO MATC H OPENING
- 5. INSTALL KINGSPAN GREEN GUARD HOUSE WRAP AND DETAIL WRAP AROUND WINDOW PER MANUFACTURER'S RECOMMENDATION
- 6. INSTALL JAMES HARDIE PLANK SIDING, SELECT CEDARMILL, 7" TW
- 7. NEW CORNER BOARDS AND TRIM 5/4 X 3.5 RUSTIC HARDIE TRIM WINDOWS - 5/4 X 3.5 HARDIE TRIM AROUND WINDOWS
- 8. ALL REQUIRED FLASHINGS TO BE GALVANIZED STEEL METAL



RECEIVE NEW SIDING, TRIM AND WINDOWS

- I. THE SCHOOL DISTRICT WILL COORDINATE WITH CONTRACTOR FOR REMOVAL OF A.C UNIT PIPING AND EQUIPMENT, AND DISCONNECT SCHOOL DISTRICT TO REMOVE ANY AND ALL CONDUITS
- 2. INSPECT ALL EXISTING SIDING AND AREA FOR DRYROT AND WATER DAMAGE. REPAIR THESE AREA PRIOR TO INSALLATION OF NEW SIDING
- 3. REMOVE ALL TRIM BOARDS
- 4. REMOVE WOOD WINDOWS INSTALL 3 NEW VINYL WINDOWS WITH BOTTOM VENTED UNIT - WINDOW TO FIT ALL 6 EXISTING WINDOW UNITS.
- 5. EXISTING DOOR TO REMAIN REMOVE TRIM AND NEW 5/4X3.5 HARDIE TRIM. SIDE OVER WINDOW UNIT ABOVE DOOR
- 6. SIDE OVER ABANDONED UNIT VENTILATOR GRILL, REMOVE GRILL AND FRAME IN AS NEEDED FOR SIDING, NEW 1/2" PLYWOOD SHTG.
- 7. INSTALL KINGSPAN GREEN GUARD HOUSE WRAP AND DETAIL WRAP AROUND WINDOW PER MANUFACTURER'S RECOMMENDATION
- 8. INSTALL JAMES HARDIE PLANK SIDING, SELECT CEDARMILL, 7" T.M.
- 9. NEW CORNER BOARDS AND TRIM 5/4 X 3.5 RUSTIC HARDIE TRIM
- 5/4 X 3.5 HARDIE TRIM AROUND NEW WINDOWS
- 10. ALL REQUIRED FLASHINGS TO BE GALVANIZED METAL

EDDYVILLE SCHOOL

EDDYVILLE, OREGON EXTERIOR SIDING REMODEL



Phone: (541) 265-5665 Fax: (541) 265-7679

A3-3

DATE: 07.30.22 SCALE: 1/4" = 1'-0" ARCHITECT: Dietmar H. Goebel

PROJECT MANAGER: DRAWN BY:











PRIOR TO ANY WORK STARTING, POWER WASH AREAS TO RECEIVE NEW SIDING, TRIM AND WINDOWS

- I. THE SCHOOL DISTRICT WILL COORDINATE WILL CONTRACTOR FOR REMOVAL OF CABLE OVER EXISTING SIDING
- 2. INSPECT ALL EXISTING SIDING AND AREA FOR DRYROT AND WATER DAMAGE. REPAIR THESE AREA PRIOR TO INSALLATION OF NEW SIDING
- 3. REMOVE ALL CORNER BOARD
- 4. REPLACEMENT OF WINDOWS: IF THE WINDOW IS A VINYL WINDOW, IT WILL REMAIN WITH ANY TRIM REMOVED. IF THE WINDOW IS A WOOD WINDOW, REMOVE THE WINDOW AND TRIM AND INSTALL A NEE VINYL WINDOW WITH NEW TRIM. ALL EXITISNG VINYL WINDOWS WILL RECEIVE NEW WINDOW TRIM, WINDOW SIZE TO MATC H OPENING
- 5. INSTALL KINGSPAN GREEN GUARD HOUSE WRAP AND DETAIL WRAP AROUND WINDOW PER MANUFACTURER'S RECOMMENDATION
- 6. INSTALL JAMES HARDIE PLANK SIDING, SELECT CEDARMILL, 7" TW
- 7. NEW CORNER BOARDS AND TRIM 5/4 X 3.5 RUSTIC HARDIE TRIM WINDOWS - 5/4 X 3.5 HARDIE TRIM AROUND WINDOWS
- 8. ALL REQUIRED FLASHINGS TO BE GALVANIZED METAL

PRIOR TO ANY WORK STARTING, POWER WASH AREAS TO RECEIVE NEW SIDING, TRIM AND WINDOWS

- I. THE SCHOOL DISTRICT WILL COORDINATE WILL CONTRACTOR FOR REMOVAL OF CABLE OVER EXISTING SIDING
- 2. INSPECT ALL EXISTING SIDING AND AREA FOR DRYROT AND WATER DAMAGE. REPAIR THESE AREA PRIOR TO INSALLATION OF NEW SIDING
- 3. REMOVE ALL CORNER BOARD
- 4. REPLACEMENT OF WINDOWS: IF THE WINDOW IS A VINYL WINDOW, IT WILL REMAIN WITH ANY TRIM REMOVED. IF THE WINDOW IS A WOOD WINDOW, REMOVE THE WINDOW AND TRIM AND INSTALL A NEE VINYL WINDOW WITH NEW TRIM. ALL EXITISNG VINYL WINDOWS WILL RECEIVE NEW WINDOW TRIM, WINDOW SIZE TO MATC H OPENING
- 5. INSTALL KINGSPAN GREEN GUARD HOUSE WRAP AND DETAIL WRAP AROUND WINDOW PER MANUFACTURER'S RECOMMENDATION
- 6. INSTALL JAMES HARDIE PLANK SIDING, SELECT CEDARMILL, 7" TW
- 7. NEW CORNER BOARDS AND TRIM 5/4 X 3.5 RUSTIC HARDIE TRIM WINDOWS - 5/4 X 3.5 HARDIE TRIM AROUND WINDOWS
- 8. ALL REQUIRED FLASHINGS TO BE GALVANIZED METAL



EDDYVILLE SCHOOL

EDDYVILLE, OREGON EXTERIOR SIDING REMODEL




Phone: (541) 265-5665 Fax: (541) 265-7679

A3-4

DATE: 07.30.22 SCALE: 1/4" = 1'-0" ARCHITECT: Dietmar H. Goebel

PROJECT MANAGER: DRAWN BY:

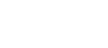











PRIOR TO ANY WORK STARTING, POWER WASH AREAS TO RECEIVE NEW SIDING, TRIM AND WINDOWS

- I. THE SCHOOL DISTRICT WILL COORDINATE WILL CONTRACTOR FOR REMOVAL OF CABLE OVER EXISTING SIDING
- 2. INSPECT ALL EXISTING SIDING AND AREA FOR DRYROT AND WATER DAMAGE. REPAIR THESE AREA PRIOR TO INSALLATION OF NEW SIDING
- 3. REMOVE ALL CORNER BOARD
- 4. REPLACEMENT OF WINDOWS: IF THE WINDOW IS A VINYL WINDOW, IT WILL REMAIN WITH ANY TRIM REMOVED. IF THE WINDOW IS A WOOD WINDOW, REMOVE THE WINDOW AND TRIM AND INSTALL A NEE VINYL WINDOW WITH NEW TRIM. ALL EXITISNG VINYL WINDOWS WILL RECEIVE NEW WINDOW TRIM, WINDOW SIZE TO MATC H OPENING
- 5. INSTALL KINGSPAN GREEN GUARD HOUSE WRAP AND DETAIL WRAP AROUND WINDOW PER MANUFACTURER'S RECOMMENDATION
- 6. INSTALL JAMES HARDIE PLANK SIDING, SELECT CEDARMILL, 7" TW
- 7. NEW CORNER BOARDS AND TRIM 5/4 X 3.5 RUSTIC HARDIE TRIM WINDOWS 5/4 X 3.5 HARDIE TRIM AROUND WINDOWS
- 8. ALL REQUIRED FLASHINGS TO BE GALVANIZED METAL
- 9. EXISTING WALL MOUNTED EQUIPMENT TO BE REMOVED AND REMOUNTED ON A NEW 5/4 HARDIE BLOCK AND FLASHED
- IO. SCHOOL DISTRICT WILL REMOVE MECHNAICAL EQUIMENT AND IPING ON BUILDING. AND REINSTALL

PRIOR TO ANY WORK STARTING, POWER WASH AREAS TO RECEIVE NEW SIDING, TRIM AND WINDOWS

- I. THE SCHOOL DISTRICT WILL COORDINATE WILL CONTRACTOR FOR REMOVAL OF CABLE OVER EXISTING SIDING
- 2. INSPECT ALL EXISTING SIDING AND AREA FOR DRYROT AND WATER DAMAGE. REPAIR THESE AREA PRIOR TO INSALLATION OF NEW SIDING
- 3. REMOVE ALL CORNER BOARD
- 4. REPLACEMENT OF WINDOWS: IF THE WINDOW IS A VINYL WINDOW, IT WILL REMAIN WITH ANY TRIM REMOVED. IF THE WINDOW IS A WOOD WINDOW, REMOVE THE WINDOW AND TRIM AND INSTALL A NEW VINYL WINDOW WITH NEW TRIM. ALL EXITISNG VINYL WINDOWS WILL RECEIVE NEW WINDOW TRIM, WINDOW SIZE TO MATC H OPENING
- 5. INSTALL KINGSPAN GREEN GUARD HOUSE WRAP AND DETAIL WRAP AROUND WINDOW PER MANUFACTURER'S RECOMMENDATION
- 6. INSTALL JAMES HARDIE PLANK SIDING, SELECT CEDARMILL, 7" TW
- 7. NEW CORNER BOARDS AND TRIM 5/4 X 3.5 RUSTIC HARDIE TRIM WINDOWS 5/4 X 3.5 HARDIE TRIM AROUND WINDOWS
- 8. ALL REQUIRED FLASHINGS TO BE GALVANIZED STEEL METAL



PRIOR TO ANY WORK STARTING, POWER WASH AREAS TO RECEIVE NEW SIDING, TRIM AND WINDOWS

- I. THE SCHOOL DISTRICT WILL COORDINATE WITH CONTRACTOR FOR REMOVAL OF A.C UNIT PIPING AND EQUIPMENT, AND DISCONNECT SCHOOL DISTRICT TO REMOVE ANY AND ALL CONDUITS
- 2. INSPECT ALL EXISTING SIDING AND AREA FOR DRYROT AND WATER DAMAGE. REPAIR THESE AREA PRIOR TO INSALLATION OF NEW SIDING
- 3. REMOVE ALL TRIM BOARDS
- 4. REMOVE WOOD WINDOWS INSTALL 3 NEW VINYL WINDOWS WITH BOTTOM VENTED UNIT WINDOW TO FIT ALL 6 EXISTING WINDOW UNITS.
- 5. EXISTING DOOR TO REMAIN REMOVE TRIM AND NEW 5/4X3.5 HARDIE TRIM. SIDE OVER WINDOW UNIT ABOVE DOOR
- 6. SIDE OVER ABANDONED UNIT VENTILATOR GRILL, REMOVE GRILL AND FRAME IN AS NEEDED FOR SIDING, NEW 1/2" PLYWOOD SHTG.
- 7. INSTALL KINGSPAN GREEN GUARD HOUSE WRAP AND DETAIL WRAP AROUND WINDOW PER MANUFACTURER'S RECOMMENDATION
- 8. INSTALL JAMES HARDIE PLANK SIDING, SELECT CEDARMILL, 7" T.W.
- 9. NEW CORNER BOARDS AND TRIM 5/4 X 3.5 RUSTIC HARDIE TRIM
- 5/4 X 3.5 HARDIE TRIM AROUND NEW WINDOWS
- 10. ALL REQUIRED FLASHINGS TO BE GALVANIZED METAL

EDDYVILLE SCHOOL

EDDYVILLE, OREGON EXTERIOR SIDING REMODEL



Phone: (541) 265-5665 Fax: (541) 265-7679

DATE: 07.30.22 SCALE: 1/4" = 1'-0"

4-|

ARCHITECT: Dietmar H. Goebel
PROJECT MANAGER:

DRAWN BY:

CHECKED BY:

B















PRIOR TO ANY WORK STARTING, POWER WASH AREAS TO RECEIVE NEW SIDING, TRIM AND WINDOWS

- I. THE SCHOOL DISTRICT WILL COORDINATE WILL CONTRACTOR FOR REMOVAL OF CABLE OVER EXISTING SIDING
- 2. INSPECT ALL EXISTING SIDING AND AREA FOR DRYROT AND WATER DAMAGE. REPAIR THESE AREA PRIOR TO INSALLATION OF NEW SIDING
- 3. REMOVE ALL CORNER BOARD
- 4. REPLACEMENT OF WINDOWS: IF THE WINDOW IS A VINYL WINDOW, IT WILL REMAIN WITH ANY TRIM REMOVED. IF THE WINDOW IS A WOOD WINDOW, REMOVE THE WINDOW AND TRIM AND INSTALL A NEE VINYL WINDOW WITH NEW TRIM. ALL EXITISNG VINYL WINDOWS WILL RECEIVE NEW WINDOW TRIM, WINDOW SIZE TO MATC H OPENING
- 5. INSTALL KINGSPAN GREEN GUARD HOUSE WRAP AND DETAIL WRAP AROUND WINDOW PER MANUFACTURER'S RECOMMENDATION
- 6. INSTALL JAMES HARDIE PLANK SIDING, SELECT CEDARMILL, 7" TW
- 7. NEW CORNER BOARDS AND TRIM 5/4 X 3.5 RUSTIC HARDIE TRIM WINDOWS 5/4 X 3.5 HARDIE TRIM AROUND WINDOWS
- 8. ALL REQUIRED FLASHINGS TO BE GALVANIZED METAL
- 9. SCHOOL DISTRICT WILL REMOVE MECHNAICAL EQUIMENT AND PIPING ON BUILDING, AND REINSTALL

PRIOR TO ANY WORK STARTING, POWER WASH AREAS TO RECEIVE NEW SIDING, TRIM AND WINDOWS

- I. THE SCHOOL DISTRICT WILL COORDINATE WILL CONTRACTOR FOR REMOVAL OF CABLE OVER EXISTING SIDING
- 2. INSPECT ALL EXISTING SIDING AND AREA FOR DRYROT AND WATER DAMAGE. REPAIR THESE AREA PRIOR TO INSALLATION OF NEW SIDING
- 3. REMOVE ALL CORNER BOARD
- 4. REPLACEMENT OF WINDOWS: IF THE WINDOW IS A VINYL WINDOW, IT WILL REMAIN WITH ANY TRIM REMOVED. IF THE WINDOW IS A WOOD WINDOW, REMOVE THE WINDOW AND TRIM AND INSTALL A NEW VINYL WINDOW WITH NEW TRIM. ALL EXITISNG VINYL WINDOWS WILL RECEIVE NEW WINDOW TRIM, WINDOW SIZE TO MATC H OPENING
- 5. INSTALL KINGSPAN GREEN GUARD HOUSE WRAP AND DETAIL WRAP AROUND WINDOW PER MANUFACTURER'S RECOMMENDATION
- 6. INSTALL JAMES HARDIE PLANK SIDING, SELECT CEDARMILL, 7" TW
- 7. NEW CORNER BOARDS AND TRIM 5/4 X 3.5 RUSTIC HARDIE TRIM WINDOWS 5/4 X 3.5 HARDIE TRIM AROUND WINDOWS
- 8. ALL REQUIRED FLASHINGS TO BE GALVANIZED STEEL METAL
 9. SIDE OVER ABANDONED UNIT VENTILATOR GRILL, REMOVE GRILL
 AND FRAME IN AS NEEDED FOR SIDING, NEW 1/2" PLYWOOD SHTG.



PRIOR TO ANY WORK STARTING, POWER WASH AREAS TO RECEIVE NEW SIDING, TRIM AND WINDOWS

- I. THE SCHOOL DISTRICT WILL COORDINATE WITH CONTRACTOR FOR REMOVAL OF A.C UNIT PIPING AND EQUIPMENT, AND DISCONNECT SCHOOL DISTRICT TO REMOVE ANY AND ALL CONDUITS
- 2. INSPECT ALL EXISTING SIDING AND AREA FOR DRYROT AND WATER DAMAGE. REPAIR THESE AREA PRIOR TO INSALLATION OF NEW SIDING
- 3. REMOVE ALL TRIM BOARDS
- 4. REMOVE WOOD WINDOWS INSTALL 3 NEW VINYL WINDOWS WITH BOTTOM VENTED UNIT WINDOW TO FIT ALL 6 EXISTING WINDOW UNITS.
- 5. EXISTING DOOR TO REMAIN REMOVE TRIM AND NEW 5/4X3.5 HARDIE TRIM. SIDE OVER WINDOW UNIT ABOVE DOOR
- 6. SIDE OVER ABANDONED UNIT VENTILATOR GRILL, REMOVE GRILL AND FRAME IN AS NEEDED FOR SIDING, NEW 1/2" PLYWOOD SHTG.
- 7. INSTALL KINGSPAN GREEN GUARD HOUSE WRAP AND DETAIL WRAP AROUND WINDOW PER MANUFACTURER'S RECOMMENDATION
- 8. INSTALL JAMES HARDIE PLANK SIDING, SELECT CEDARMILL, 7" T.W.
- 9. NEW CORNER BOARDS AND TRIM 5/4 X 3.5 RUSTIC HARDIE TRIM
- 5/4 X 3.5 HARDIE TRIM AROUND NEW WINDOWS
- 10. ALL REQUIRED FLASHINGS TO BE GALVANIZED METAL

EDDYVILLE SCHOOL

EDDYVILLE, OREGON EXTERIOR SIDING REMODEL



| 147 NE Golf Course Drive - Newport, Oregon 97365 | Phone: (541) 265-5665 | Fax: (541) 265-7679 | DATE: 07.30.22 | SCALE: |/4" = |'-0"

DATE: 07.30.22 SCA

ARCHITECT: Dietmar H. Goebel

PROJECT MANAGER:









DRAWN BY:

CHECKED BY:









PRIOR TO ANY WORK STARTING, POWER WASH AREAS TO RECEIVE NEW SIDING, TRIM AND WINDOWS

- I. THE SCHOOL DISTRICT WILL COORDINATE WILL CONTRACTOR FOR REMOVAL OF CABLE OVER EXISTING SIDING
- 2. INSPECT ALL EXISTING SIDING AND AREA FOR DRYROT AND WATER DAMAGE. REPAIR THESE AREA PRIOR TO INSALLATION OF NEW SIDING
- 3. REMOVE ALL CORNER BOARD
- 4. REPLACEMENT OF WINDOWS: IF THE WINDOW IS A VINYL WINDOW, IT WILL REMAIN WITH ANY TRIM REMOVED. IF THE WINDOW IS A WOOD WINDOW, REMOVE THE WINDOW AND TRIM AND INSTALL A NEE VINYL WINDOW WITH NEW TRIM. ALL EXITISNG VINYL WINDOWS WILL RECEIVE NEW WINDOW TRIM, WINDOW SIZE TO MATC H OPENING
- 5. INSTALL KINGSPAN GREEN GUARD HOUSE WRAP AND DETAIL WRAP AROUND WINDOW PER MANUFACTURER'S RECOMMENDATION
- 6. INSTALL JAMES HARDIE PLANK SIDING, SELECT CEDARMILL, 7" TW
- 7. NEW CORNER BOARDS AND TRIM 5/4 X 3.5 RUSTIC HARDIE TRIM WINDOWS 5/4 X 3.5 HARDIE TRIM AROUND WINDOWS
- 8. ALL REQUIRED FLASHINGS TO BE GALVANIZED METAL
- 9. SCHOOL DISTRICT WILL REMOVE MECHNAICAL EQUIMENT AND PIPING ON BUILDING, AND REINSTALL

PRIOR TO ANY WORK STARTING, POWER WASH AREAS TO RECEIVE NEW SIDING, TRIM AND WINDOWS

- I. THE SCHOOL DISTRICT WILL COORDINATE WILL CONTRACTOR FOR REMOVAL OF CABLE OVER EXISTING SIDING
- 2. INSPECT ALL EXISTING SIDING AND AREA FOR DRYROT AND WATER DAMAGE. REPAIR THESE AREA PRIOR TO INSALLATION OF NEW SIDING
- 3. REMOVE ALL CORNER BOARD
- 4. REPLACEMENT OF WINDOWS: IF THE WINDOW IS A VINYL WINDOW, IT WILL REMAIN WITH ANY TRIM REMOVED. IF THE WINDOW IS A WOOD WINDOW, REMOVE THE WINDOW AND TRIM AND INSTALL A NEW VINYL WINDOW WITH NEW TRIM. ALL EXITISNG VINYL WINDOWS WILL RECEIVE NEW WINDOW TRIM, WINDOW SIZE TO MATC H OPENING
- 5. INSTALL KINGSPAN GREEN GUARD HOUSE WRAP AND DETAIL WRAP AROUND WINDOW PER MANUFACTURER'S RECOMMENDATION
- 6. INSTALL JAMES HARDIE PLANK SIDING, SELECT CEDARMILL, 7" TW
- 7. NEW CORNER BOARDS AND TRIM 5/4 X 3.5 RUSTIC HARDIE TRIM WINDOWS 5/4 X 3.5 HARDIE TRIM AROUND WINDOWS
- 8. ALL REQUIRED FLASHINGS TO BE GALVANIZED STEEL METAL
- 9. SCHOOL DISTRICT WILL REMOVE MECHNAICAL EQUIMENT AND PIPING ON BUILDING, AND REINSTALL



EDDYVILLE SCHOOL

EDDYVILLE, OREGON EXTERIOR SIDING REMODEL

DHGOebel Oregon Coast Architect

Phone: (541) 265-5665 Fax: (541) 265-7679

DATE: 07.30.22 SCALE: 1/4" = 1'-0"


A4-3


DATE: 07.30.22 SC ARCHITECT: Dietmar H. Goebel PROJECT MANAGER:

DRAWN BY:

CHECKED BY:

6

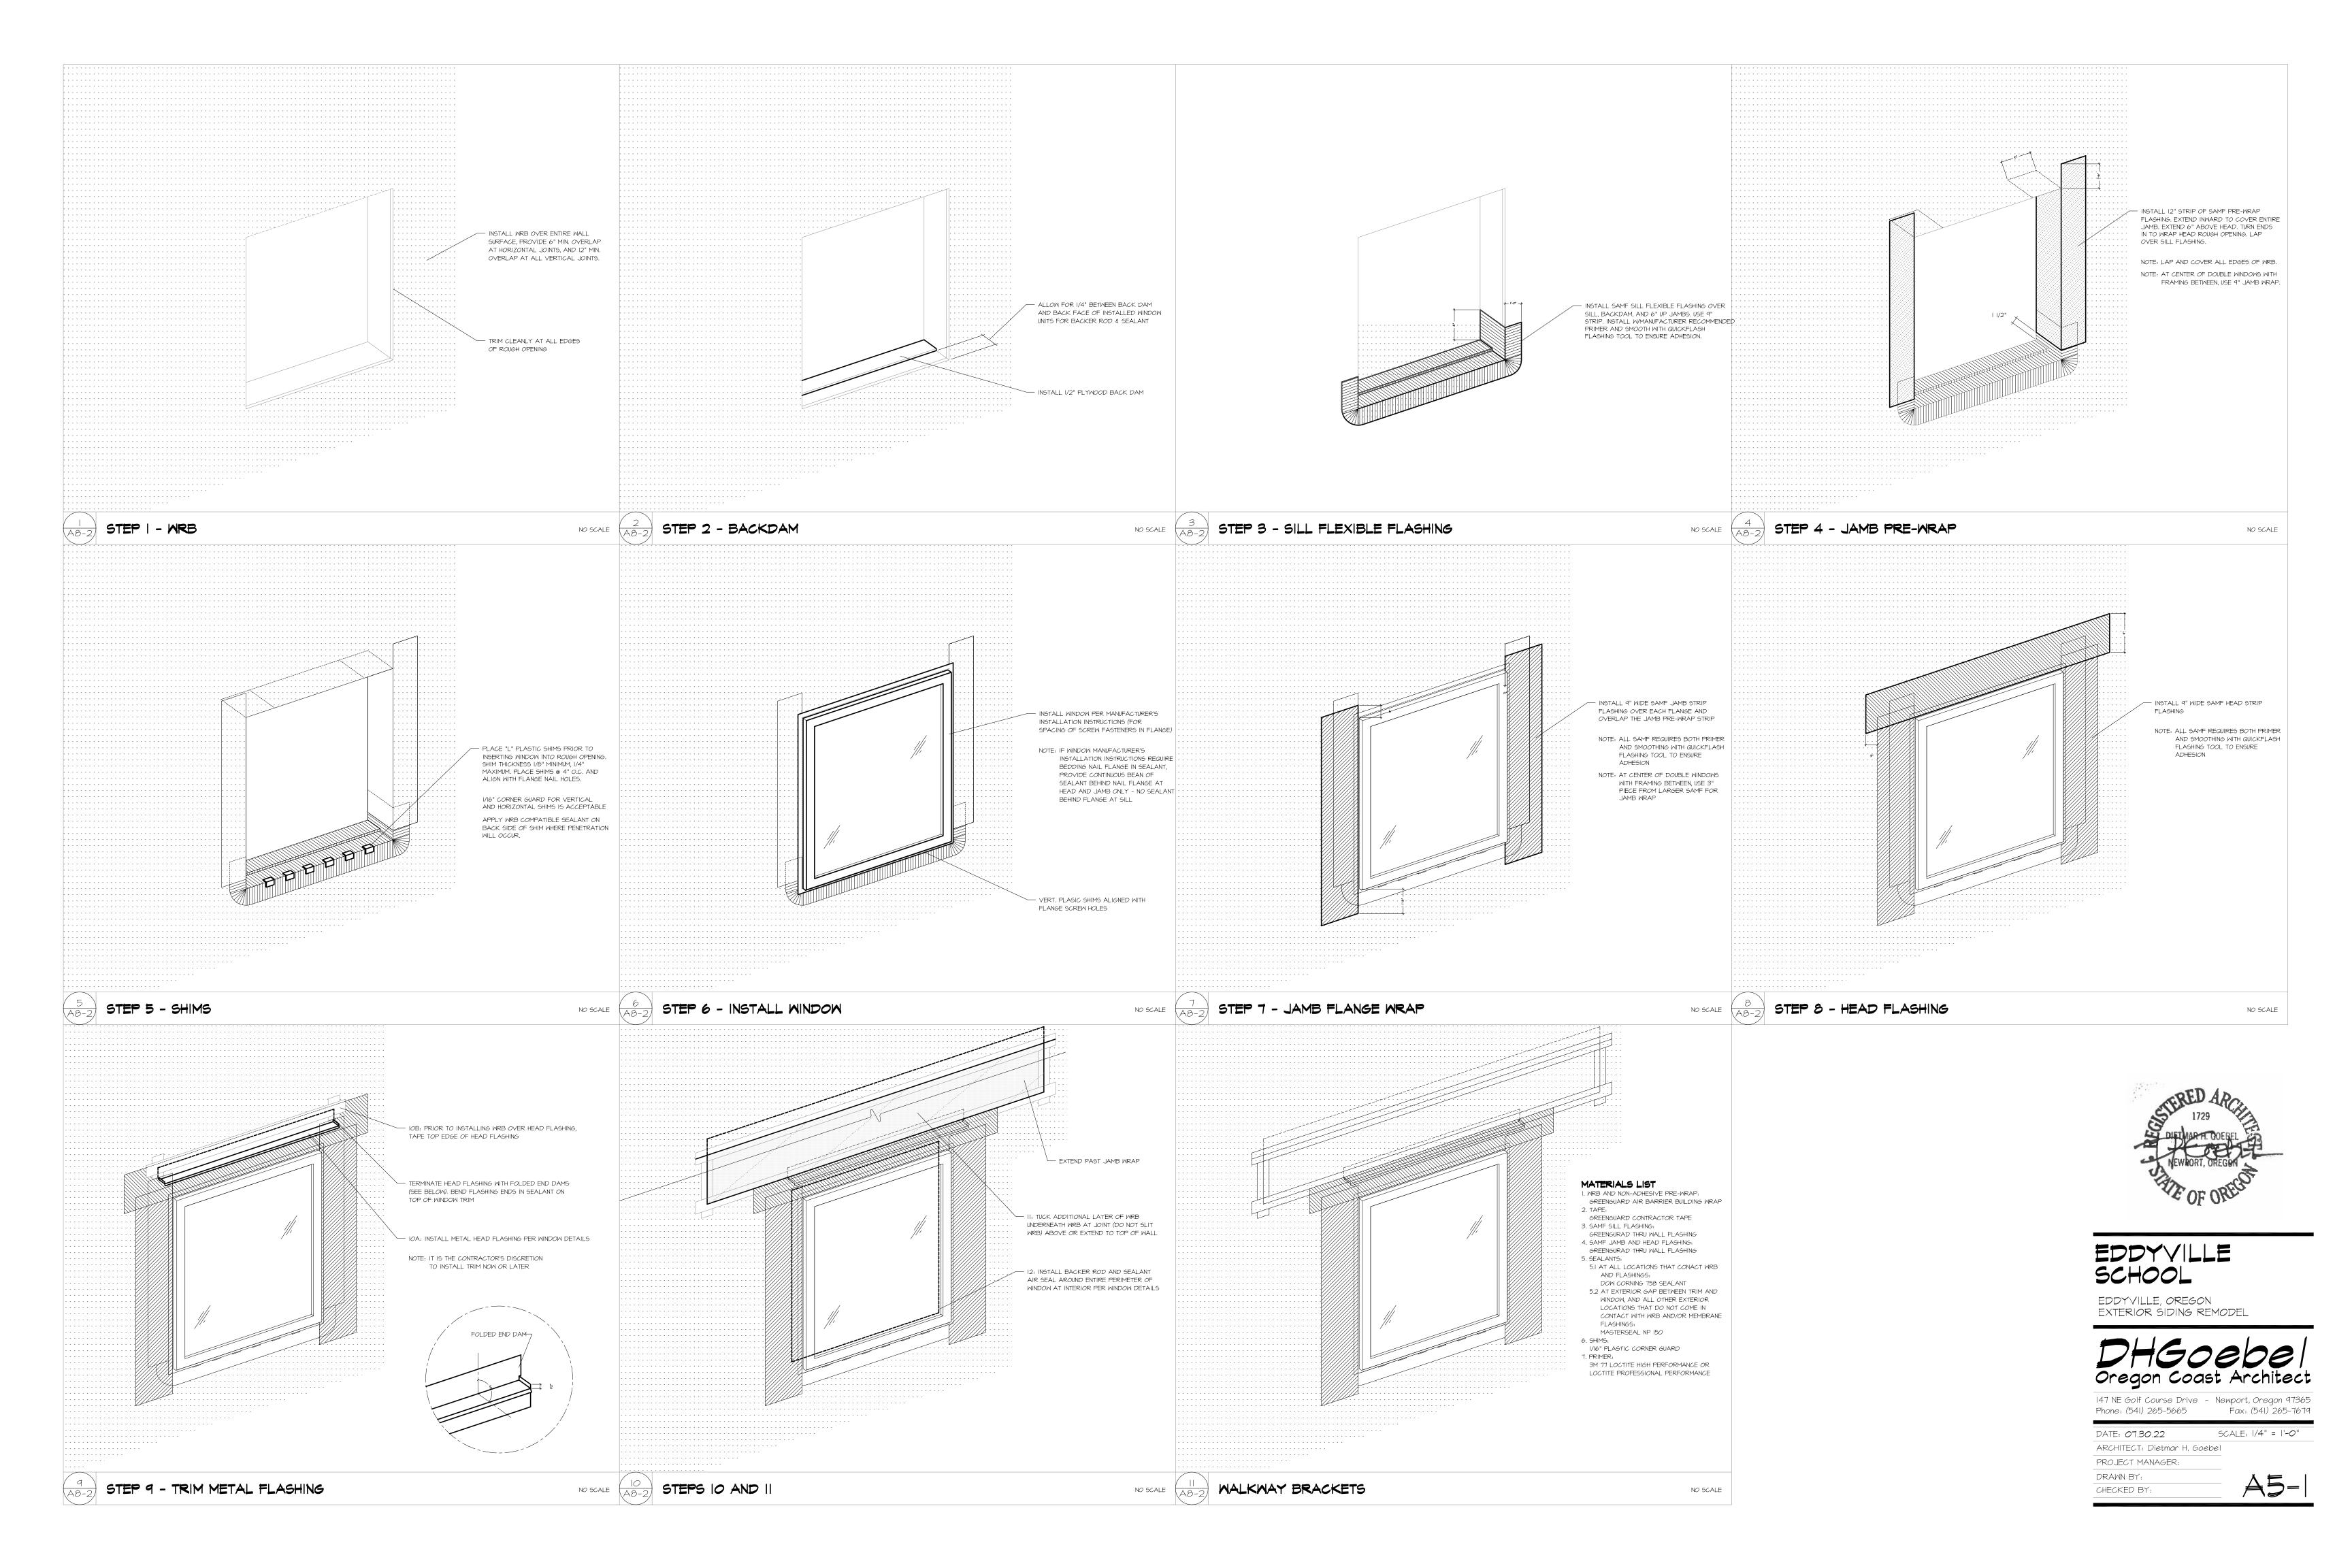

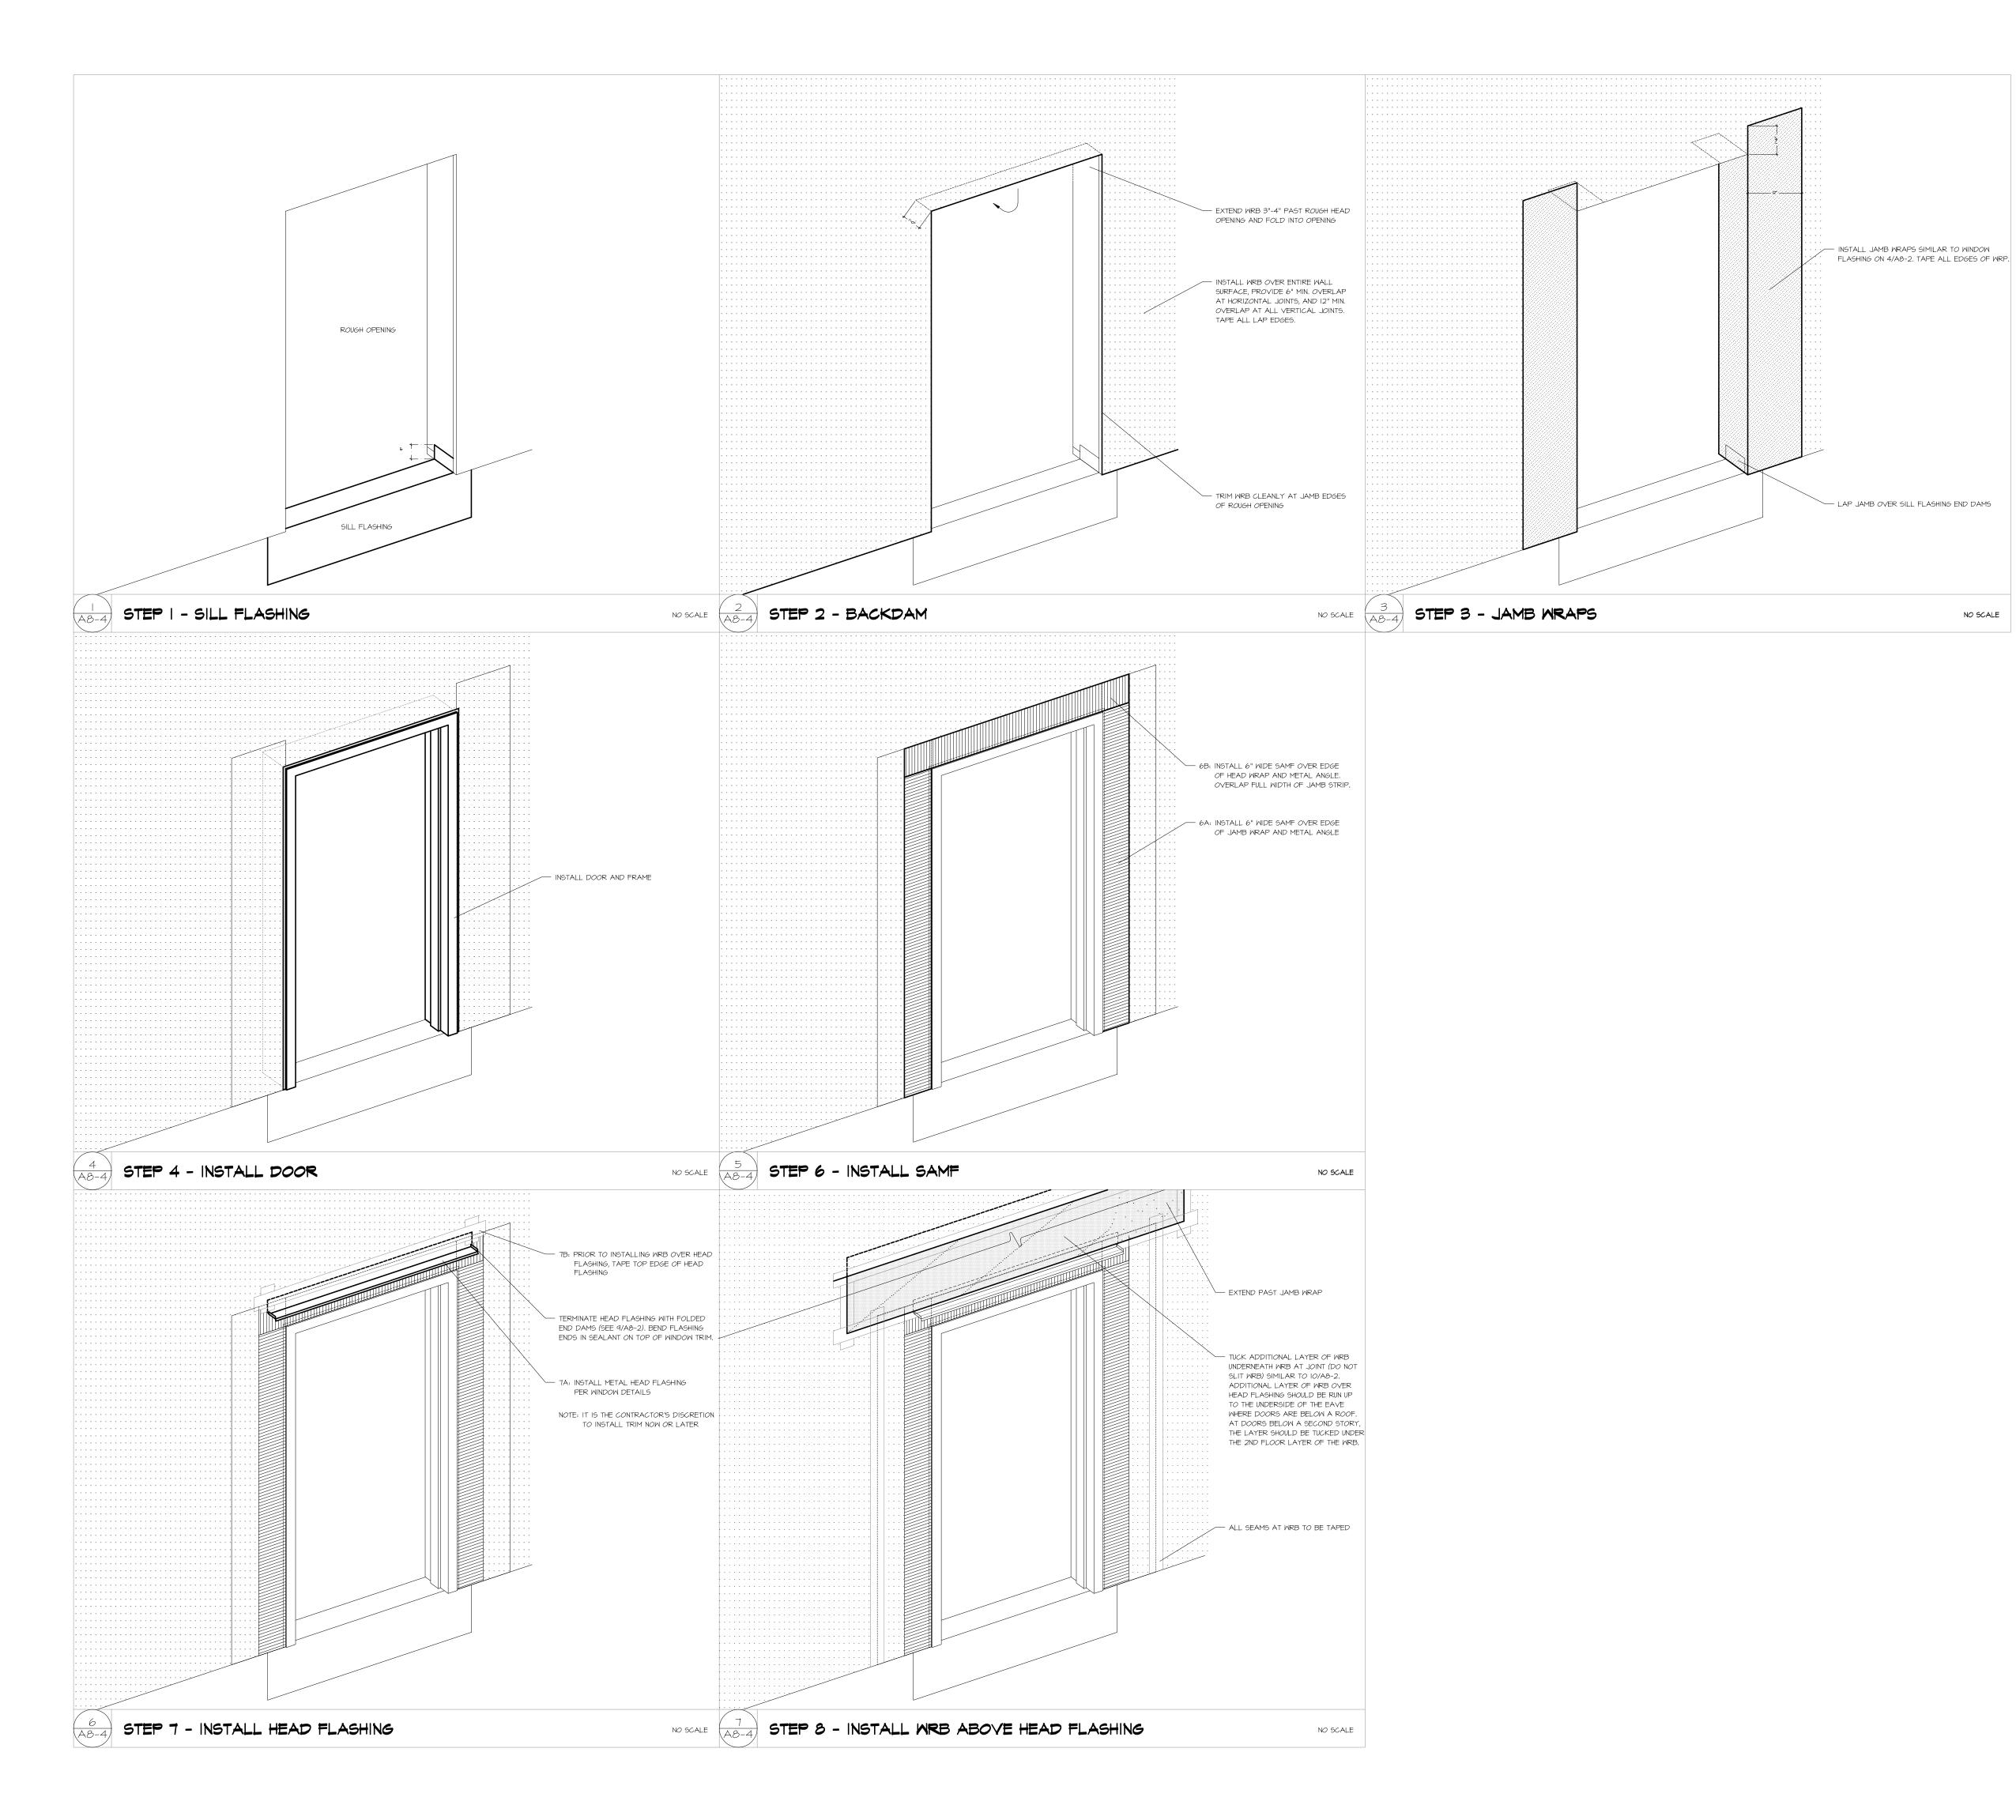



EDDYVILLE SCHOOL

EDDYVILLE, OREGON EXTERIOR SIDING REMODEL

DHGOebe Oregon Coast Architec

147 NE Golf Course Drive - Newport, Oregon 97365 Phone: (541) 265-5665 Fax: (541) 265-7679

DATE: 07.30.22 SCALE: 1/4" = 1'-0"


ARCHITECT: Dietmar H. Goebel

PROJECT MANAGER:

DRAWN BY:

CHECKED BY:

— A5-

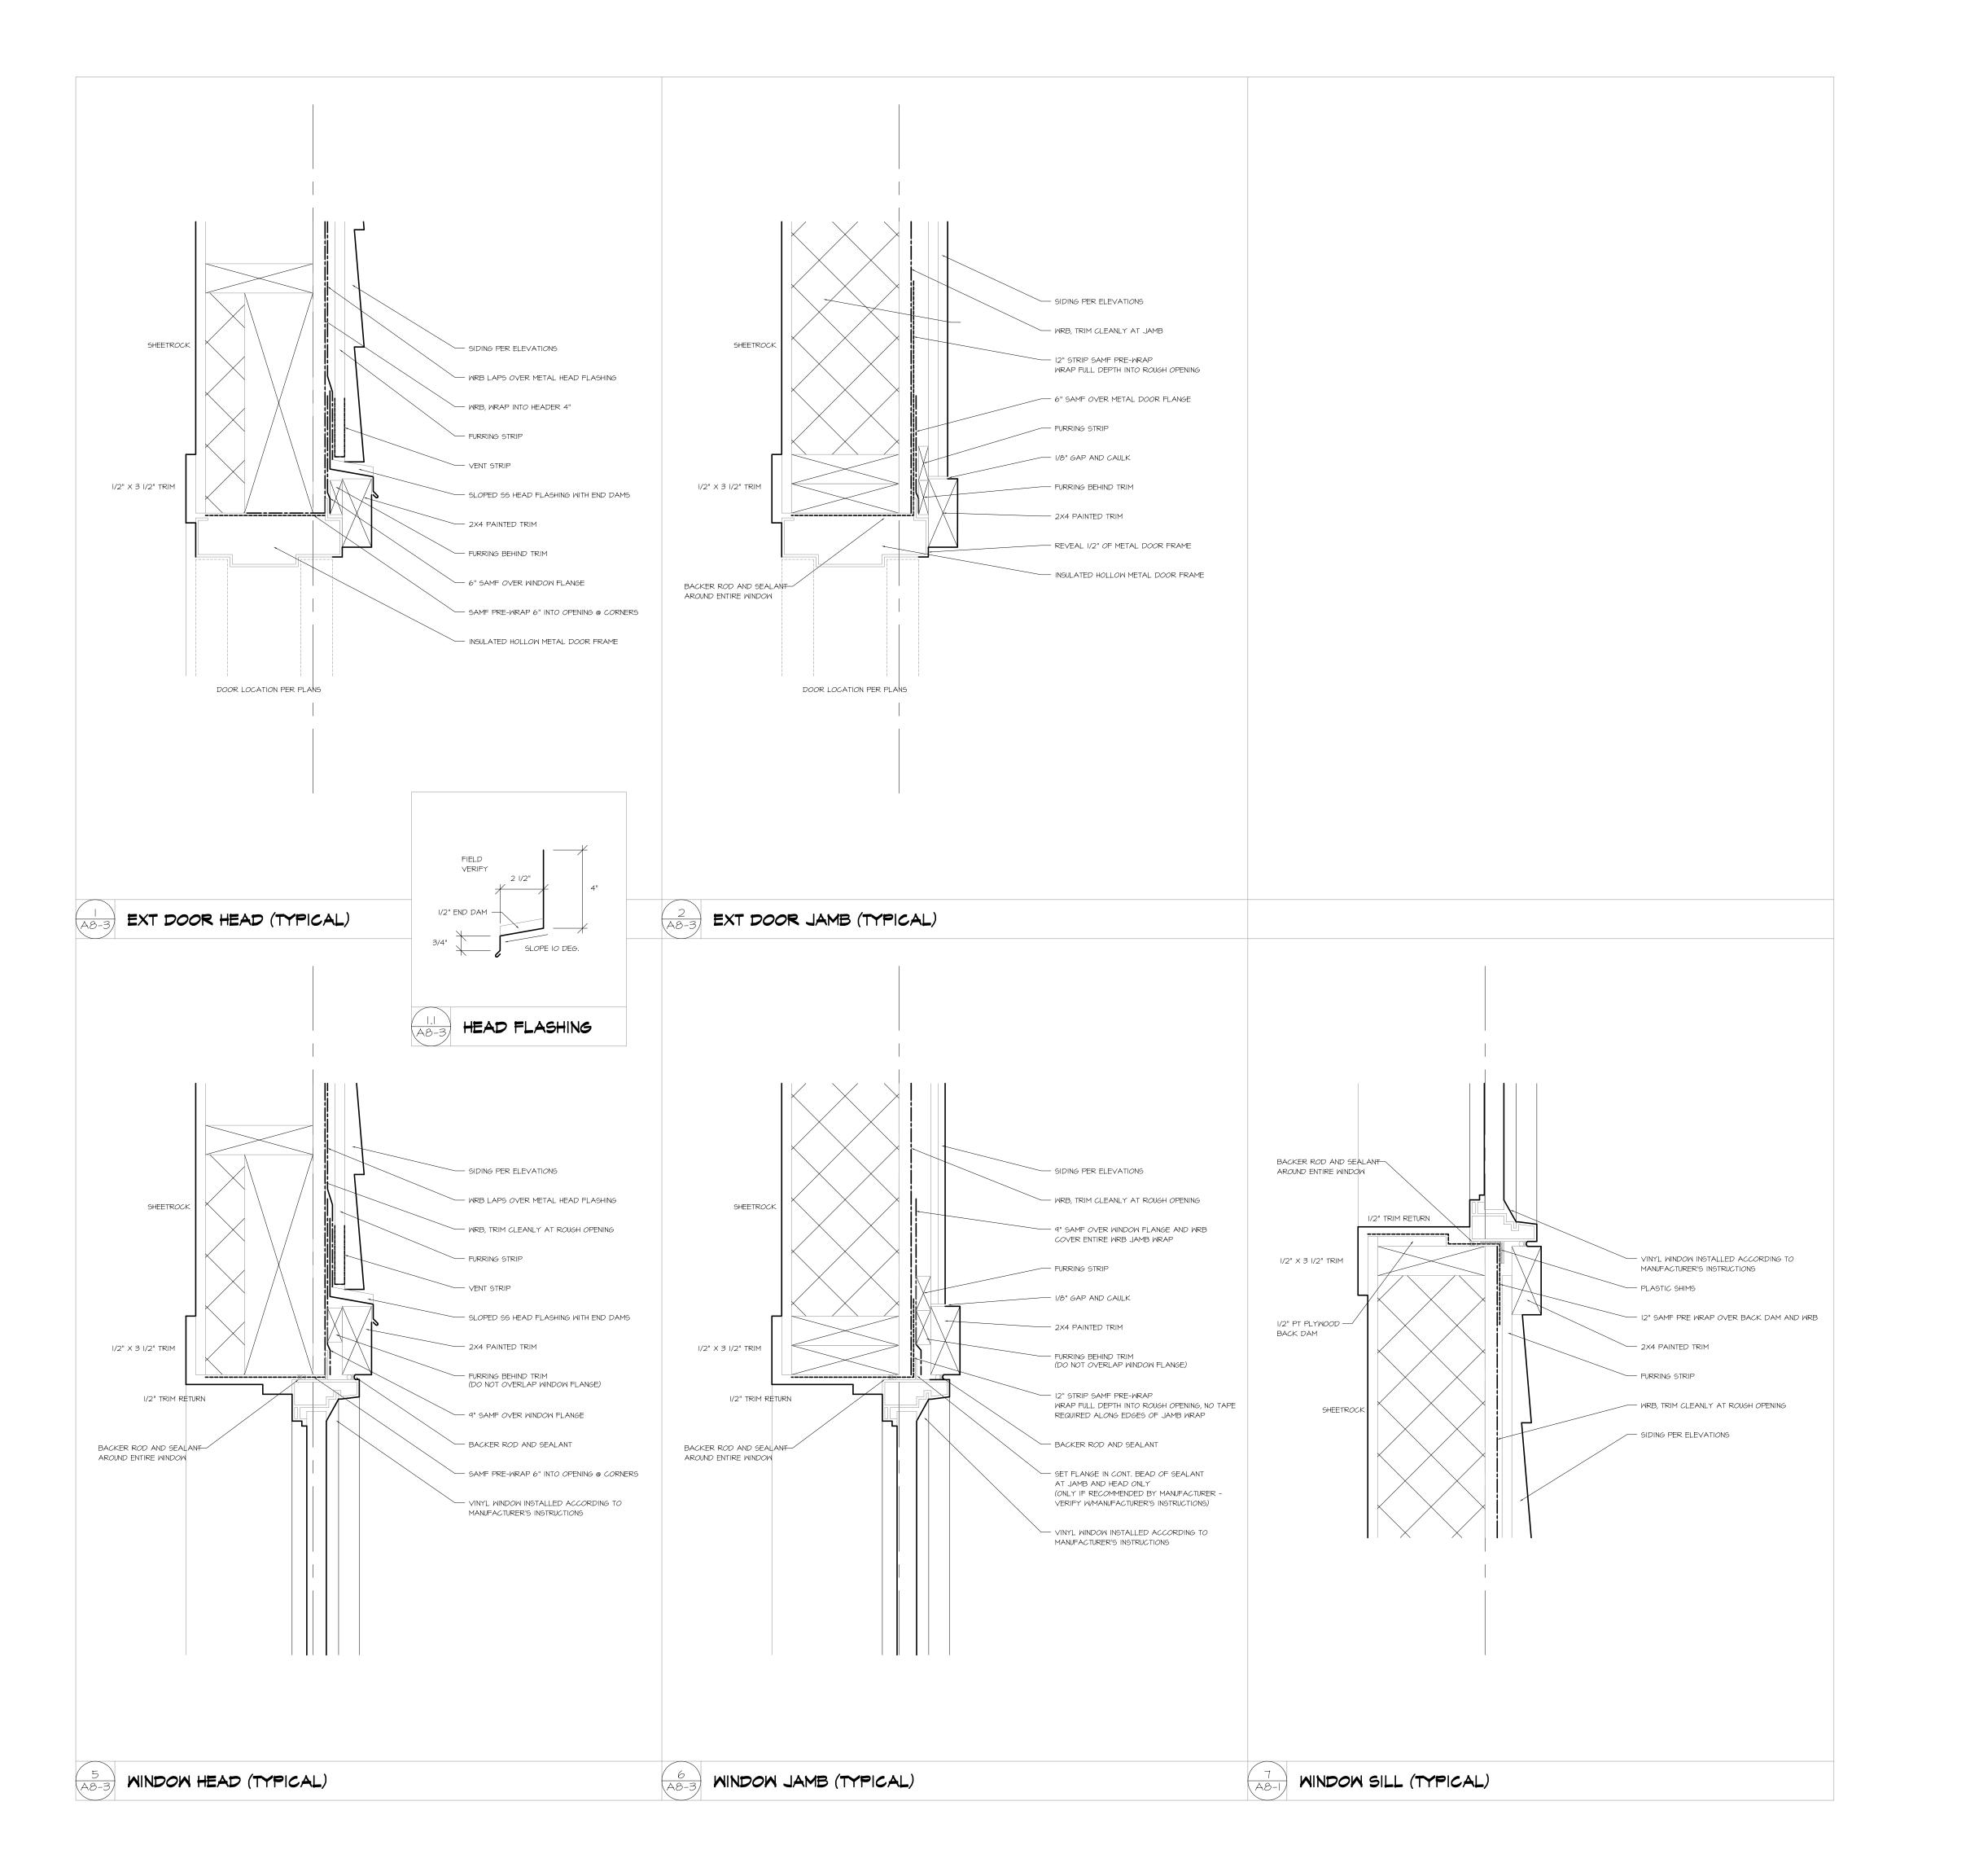



EDDYVILLE SCHOOL

EDDYVILLE, OREGON EXTERIOR SIDING REMODEL



 147 NE Golf Course Drive - Newport, Oregon 97365

 Phone: (541) 265-5665
 Fax: (541) 265-7679

DATE: 07.30.22 SCALE: |" = |'-0"

ARCHITECT: Dietmar H. Goebel

PROJECT MANAGER: DRAWN BY:

DRAWN BY:
CHECKED BY: